


COUNTY OF	ITEM NO.	SHEET NO.
FRANKLIN	5-565	L-000

TREE PRESERVATION AND REMOVAL NOTES


- THIS PLAN REPRESENTS TREES TO BE REMOVED PRIOR TO EXCAVATION AND CONSTRUCTION.
- REMOVE STUMP AND ROOTS FOR ALL WOODY PLANT REMOVALS AS DIRECTED BY LANDSCAPE ARCHITECT; GRIND STUMPS TO MINIMUM 12" BELOW FINAL GRADE.
- CONTRACTOR RESPONSIBLE FOR REMOVING TREES AS INDICATED ON PLAN IN A SAFE MANNER WITHOUT DAMAGE TO SURROUNDING STRUCTURES, PAVEMENT AND AMENITIES. ANY DAMAGES SHALL BE THE RESPONSIBILITY OF THE CONTRACTOR TO REPAIR TO THE OWNER'S SATISFACTION. FOLLOW ALL SAFETY REGULATIONS, ISA & OSHA STANDARDS ANSI Z133.1, SAFETY OF THE PUBLIC AND WORKERS IS TO BE PRIMARY CONSIDERATION IN THE WORK.
- THE CONTRACTOR WILL PROVIDE A CERTIFIED ARBORIST WITH CURRENT CERTIFICATION FROM THE INTERNATIONAL SOCIETY OF ARBORICULTURE. THIS PERSON SHALL BE RESPONSIBLE FOR EVALUATING TREES BEFORE AND DURING CONSTRUCTION, EVALUATING DAMAGE THAT MAY HAVE OCCURRED DURING CONSTRUCTION, ADVISING THE OWNER AND CONTRACTORS DURING CONSTRUCTION REGARDING ALL WORK AROUND EXISTING TREES AND SEEING THAT WORK IS PERFORMED TO STANDARDS IN A SAFE, PROFESSIONAL, AND TIMELY MANNER THAT PROVIDES EXISTING TREES WITH THE BEST POTENTIAL CHANCES FOR MINIMIZING IMPACTS, SURVIVAL AND OPTIMAL HEALTH AFTER CONSTRUCTION.
- NO SITE PREPARATION WORK, INCLUDING DEMOLITION, STAGING OR ANY DELIVERY/STORAGE OF MATERIALS, SHALL BEGIN IN AREAS WHERE TREES ARE DESIGNATED TO REMAIN AND BE PROTECTED.
- FURNISH ALL LABOR, MATERIALS, SUPPLIES, EQUIPMENT AND TOOLS TO PERFORM ALL OPERATIONS IN CONNECTION WITH AND REASONABLY INCIDENTAL TO PRESERVE OR REPAIR TREES DAMAGED BY CONSTRUCTION. THE WORK SHALL INCLUDE BUT NOT BE LIMITED TO, THE FOLLOWING:
 - ROOT PRUNING AS INDICATED ON DRAWINGS.
 - ADDITIONAL PROTECTION MEASURES AS RECOMMENDED BY THE CERTIFIED ARBORIST.
 - REPAIR OPERATIONS RECOMMENDED BY THE CERTIFIED ARBORIST.
 - PAYMENTS OR REPLACEMENTS FOR DAMAGED TREES AS RECOMMENDED BY THE CERTIFIED ARBORIST.
- CONSTRUCTION ACTIVITY WITHIN THE ROOT ZONE OF EXISTING TREES TO REMAIN AND SHALL BE PROHIBITED AND CAN BE CONSIDERED DAMAGE TO THE TREE. THIS SHALL INCLUDE BUT IS NOT LIMITED TO THE FOLLOWING ACTIVITIES:
 - PARKING OR DRIVING EQUIPMENT, MACHINERY OR VEHICLES.
 - STORING CONSTRUCTION MATERIALS, EQUIPMENT, STOCKPILING, EXCAVATION OR FILL, SOIL, GRAVEL, ETC.
 - DUMPING CHEMICALS, (I.E., PAINT THINNER FROM CLEANING BRUSHES), WASH-OUT MATERIALS FROM CLEANING EQUIPMENT, CONCRETE OR MORTAR REMAINDER, TRASH, GARBAGE, OR DEBRIS.
 - BURNING WITHIN OR IN PROXIMITY TO PROTECTED AREAS.
- TRENCHING OR GRADING WITHIN THE DRIP LINES OF PROTECTED TREES WITHOUT NOTIFYING THE CERTIFIED ARBORIST AND OWNER'S REPRESENTATIVE IN WRITING 10 DAYS IN ADVANCE OF OPERATION. THIS INCLUDES UTILITIES, LIGHTING, IRRIGATION, DRAINAGE, PAVING, STRUCTURES, ETC.
- TRENCHING OR GRADING WITHOUT ROOT PRUNING ANY CONSTRUCTION ACTIVITY WITHIN THE DRIP LINE OF AN EXISTING TREE NOT COORDINATED WITH AND APPROVED BY THE CERTIFIED ARBORIST.
- ANY WORK REQUIRED BY PLANS WHICH IS IN A TREE PRESERVATION AREA SHALL BE PERFORMED BY HAND OR METHOD(S) OTHERWISE APPROVED BY CERTIFIED ARBORIST, OWNER'S REPRESENTATIVE, AND LANDSCAPE ARCHITECT. ALL WORK WILL BE PERFORMED IN A MANNER TO PREVENT COMPACTION, SILTATION, AND DISTURBANCE OF THE ROOT ZONE OF ALL TREES DESIGNATED FOR PRESERVATION.
- CONTRACTOR SHALL BE RESPONSIBLE FOR INSURING THAT ALL SUBCONTRACTORS ARE AWARE OF, AND ADHERE TO, TREE PRESERVATION REQUIREMENTS.
- WHERE EXCAVATION OR CONSTRUCTION WITHIN THE DRIP LINE OF A TREE IS NECESSARY OR AS NOTED ON DRAWINGS, A ROOT CUT SHALL BE MADE AS DESCRIBED BELOW. BLADE SHALL BE SHARPENED PRIOR TO USE.
 - ROOT CUTS SHALL BE MARKED IN THE FIELD BY THE CONTRACTOR AND REVIEWED BY THE CERTIFIED ARBORIST PRIOR TO CUTTING.
 - ONCE REVIEWED BY THE CERTIFIED ARBORIST, THE CONTRACTOR SHALL FOLLOW HIS/HER RECOMMENDATIONS TO CUT ALONG THE APPROVED MARKS PRIOR TO ANY EXCAVATION.
 - THE ARBORIST SHALL ALSO MAKE ANY RECOMMENDATIONS RELATED TO PRESERVING ANY CRITICAL STRUCTURAL ROOTS DURING THE CUTTING PROCESS. (THIS IS THE CLOSEST POINT TO THIS PARTICULAR TREE THAT THE SOIL CAN BE DISTURBED.)
 - THE CONTRACTOR SHALL PRUNE ALL ROOTS AS DIRECTED WITH CIRCULAR SAWS OF VARYING TYPES AND/OR A ROTARY TYPE STUMP GRINDER TO A DEPTH OF 18" OR TO THE MAXIMUM DEPTH OF THE REQUIRED GRADING CUT, WHICHEVER IS LESS.
 - ROOT PRUNING SHALL BE COORDINATED WITH THE TREE PROTECTION FENCING. IN SOME CASES THAT FENCE LINE IS ON THE ROOT CUT AND PROVISIONS FOR ROOT PRUNING NEED TO BE ACCOMMODATED BEFORE THE FENCE IS ERECTED.
 - DURING THE EXCAVATION PROCESS, IF ROOTS GREATER THAN 3" IN DIAMETER, THAT HAVE NOT BEEN ROOT PRUNED ARE ENCOUNTERED, THEY SHALL BE CUT WITH A SAW OR SHARP AXE AND NOT RIPPED WITH THE EARTH MOVING EQUIPMENT, AS DIRECTED BY THE ARBORIST. THE ARBORIST IS TO REVIEW ANY ROOTS OVER 3" ENCOUNTERED, TO DETERMINE STRUCTURAL STABILITY OF THE TREE.
- TREE FOLIAGE AND BRANCHES SHOULD BE AVOIDED BY CONSTRUCTION EQUIPMENT. IF CONTACT SHOULD BE DEEMED NECESSARY BY CONTRACTOR, CONSULT CERTIFIED ARBORIST FOR PROPER PRUNING OF LIMBS BEFORE ANY WORK THAT WILL IMPACT TREE.
- THESE NOTES APPLY TO ALL L-0XX SERIES DRAWINGS

GENERAL NOTES


- BASE INFORMATION PROVIDED BY STRAND ASSOCIATES, Inc. 651 PERIMETER DRIVE, SUITE 220 LEXINGTON, KY 40517
- CONTRACTOR SHALL LOCATE ALL UTILITIES, STRUCTURES, PAVEMENT AND VEGETATION TO REMAIN, AND TAKE THE NECESSARY PRECAUTIONS FOR THEIR PROTECTION DURING CONSTRUCTION. ANY FIELD ADJUSTMENTS REQUIRED SHALL BE REVIEWED BY THE LANDSCAPE ARCHITECT PRIOR TO IMPLEMENTATION.
- CONTRACTOR SHALL BE RESPONSIBLE FOR MEETING ALL APPLICABLE FEDERAL, STATE AND LOCAL CODES, LAWS, ORDINANCES, RULES AND REGULATIONS DURING THE COURSE OF THIS PROJECT, INCLUDING BUT NOT LIMITED TO OSHA REQUIREMENTS FOR PUBLIC AND WORKER SAFETY.
- CONTRACTOR SHALL COORDINATE WITH THE WORK OF OTHER TRADES TO ENSURE PROPER AND TIMELY EXECUTION OF THE WORK.

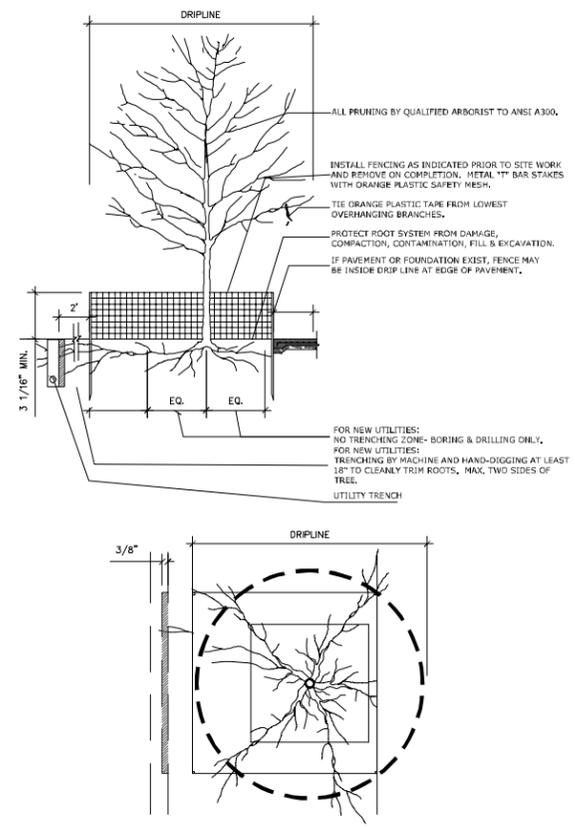

1 TYPICAL TREE PRESERVATION DETAIL
SCALE: NTS

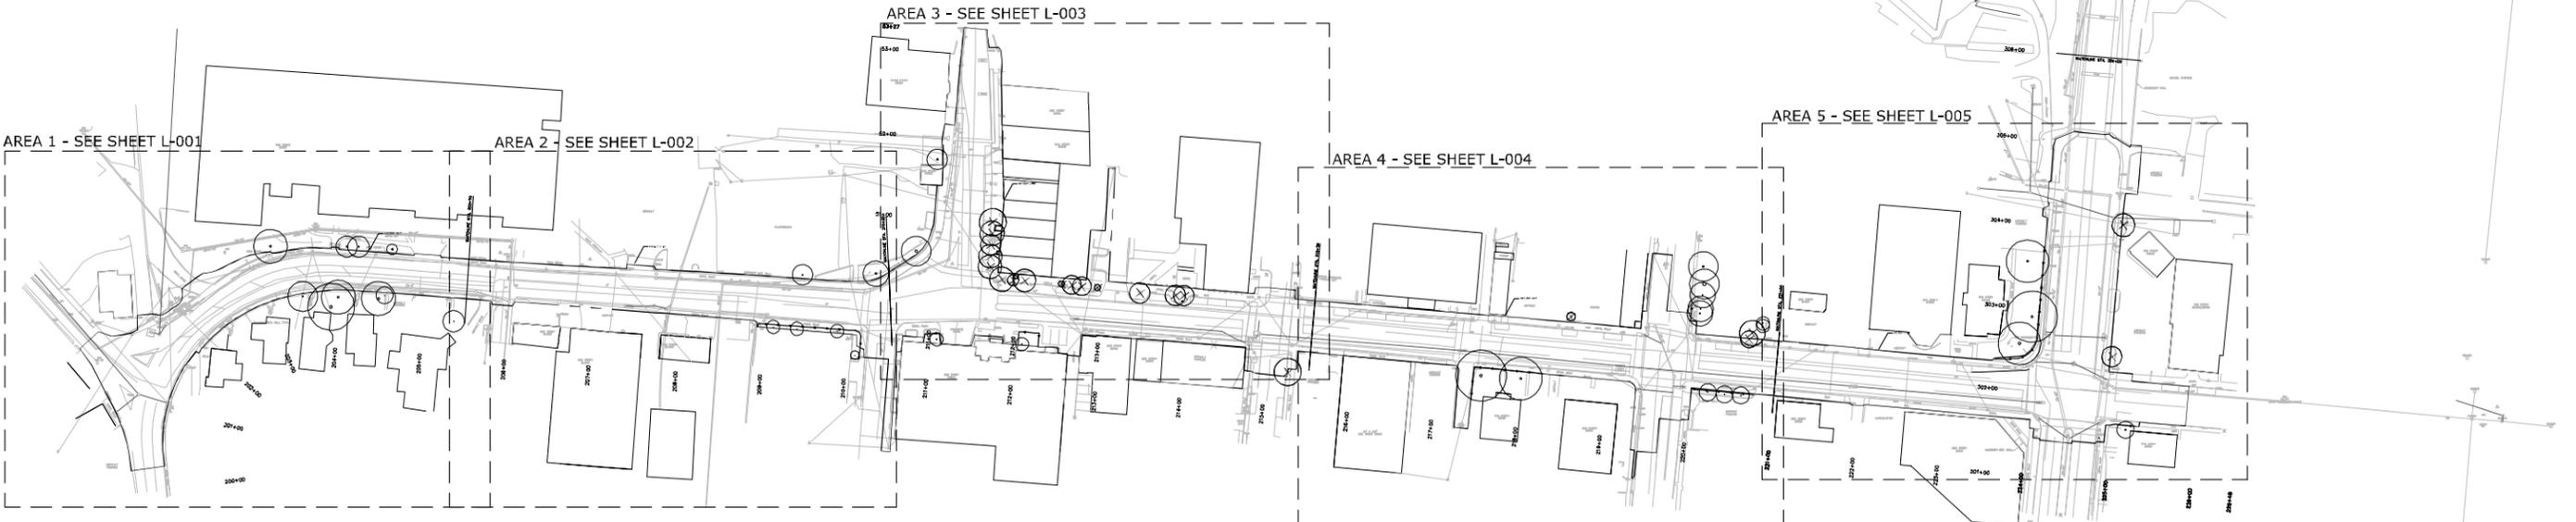

LEGEND - TREE PRESERVATION SYMBOLS		
KEY	ITEM	COMMENTS
	EXISTING TREE TO REMAIN & BE PROTECTED	SEE NOTES & SPECIFICATIONS; COORDINATE WITH CERTIFIED ARBORIST PROVIDED BY OWNER
	EXISTING TREE TO BE REMOVED	SEE NOTES & SPECIFICATIONS; COORDINATE WITH CERTIFIED ARBORIST PROVIDED BY OWNER
	TREE PRESERVATION FENCING	ORANGE CONSTRUCTION TYPE FENCING, 4' HIGH WITH METAL POSTS SUPPORTING FENCE MATERIAL APPROX. 6" O.C.; FENCING ALONG DRIP LINE OR AS SHOWN ON PLAN, WHICHEVER IS CLOSER TO TREE, AS SHOWN IN PLAN


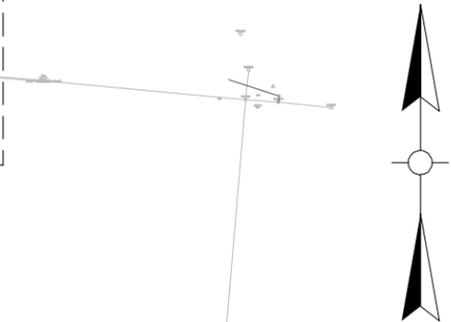


FILE NAME: X:\21900 PROJECTS\21906 (FRANKFORT 2ND STREET)\AUTOCAD\03_DD\L-001 TREE PROTECTION PLAN - AREA 1.DWG

USER: nhh
DATE PLOTTED: March 11, 2020

E-SHEET NAME:

Power InRoads v8.11.7.443

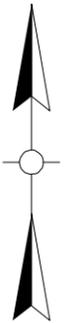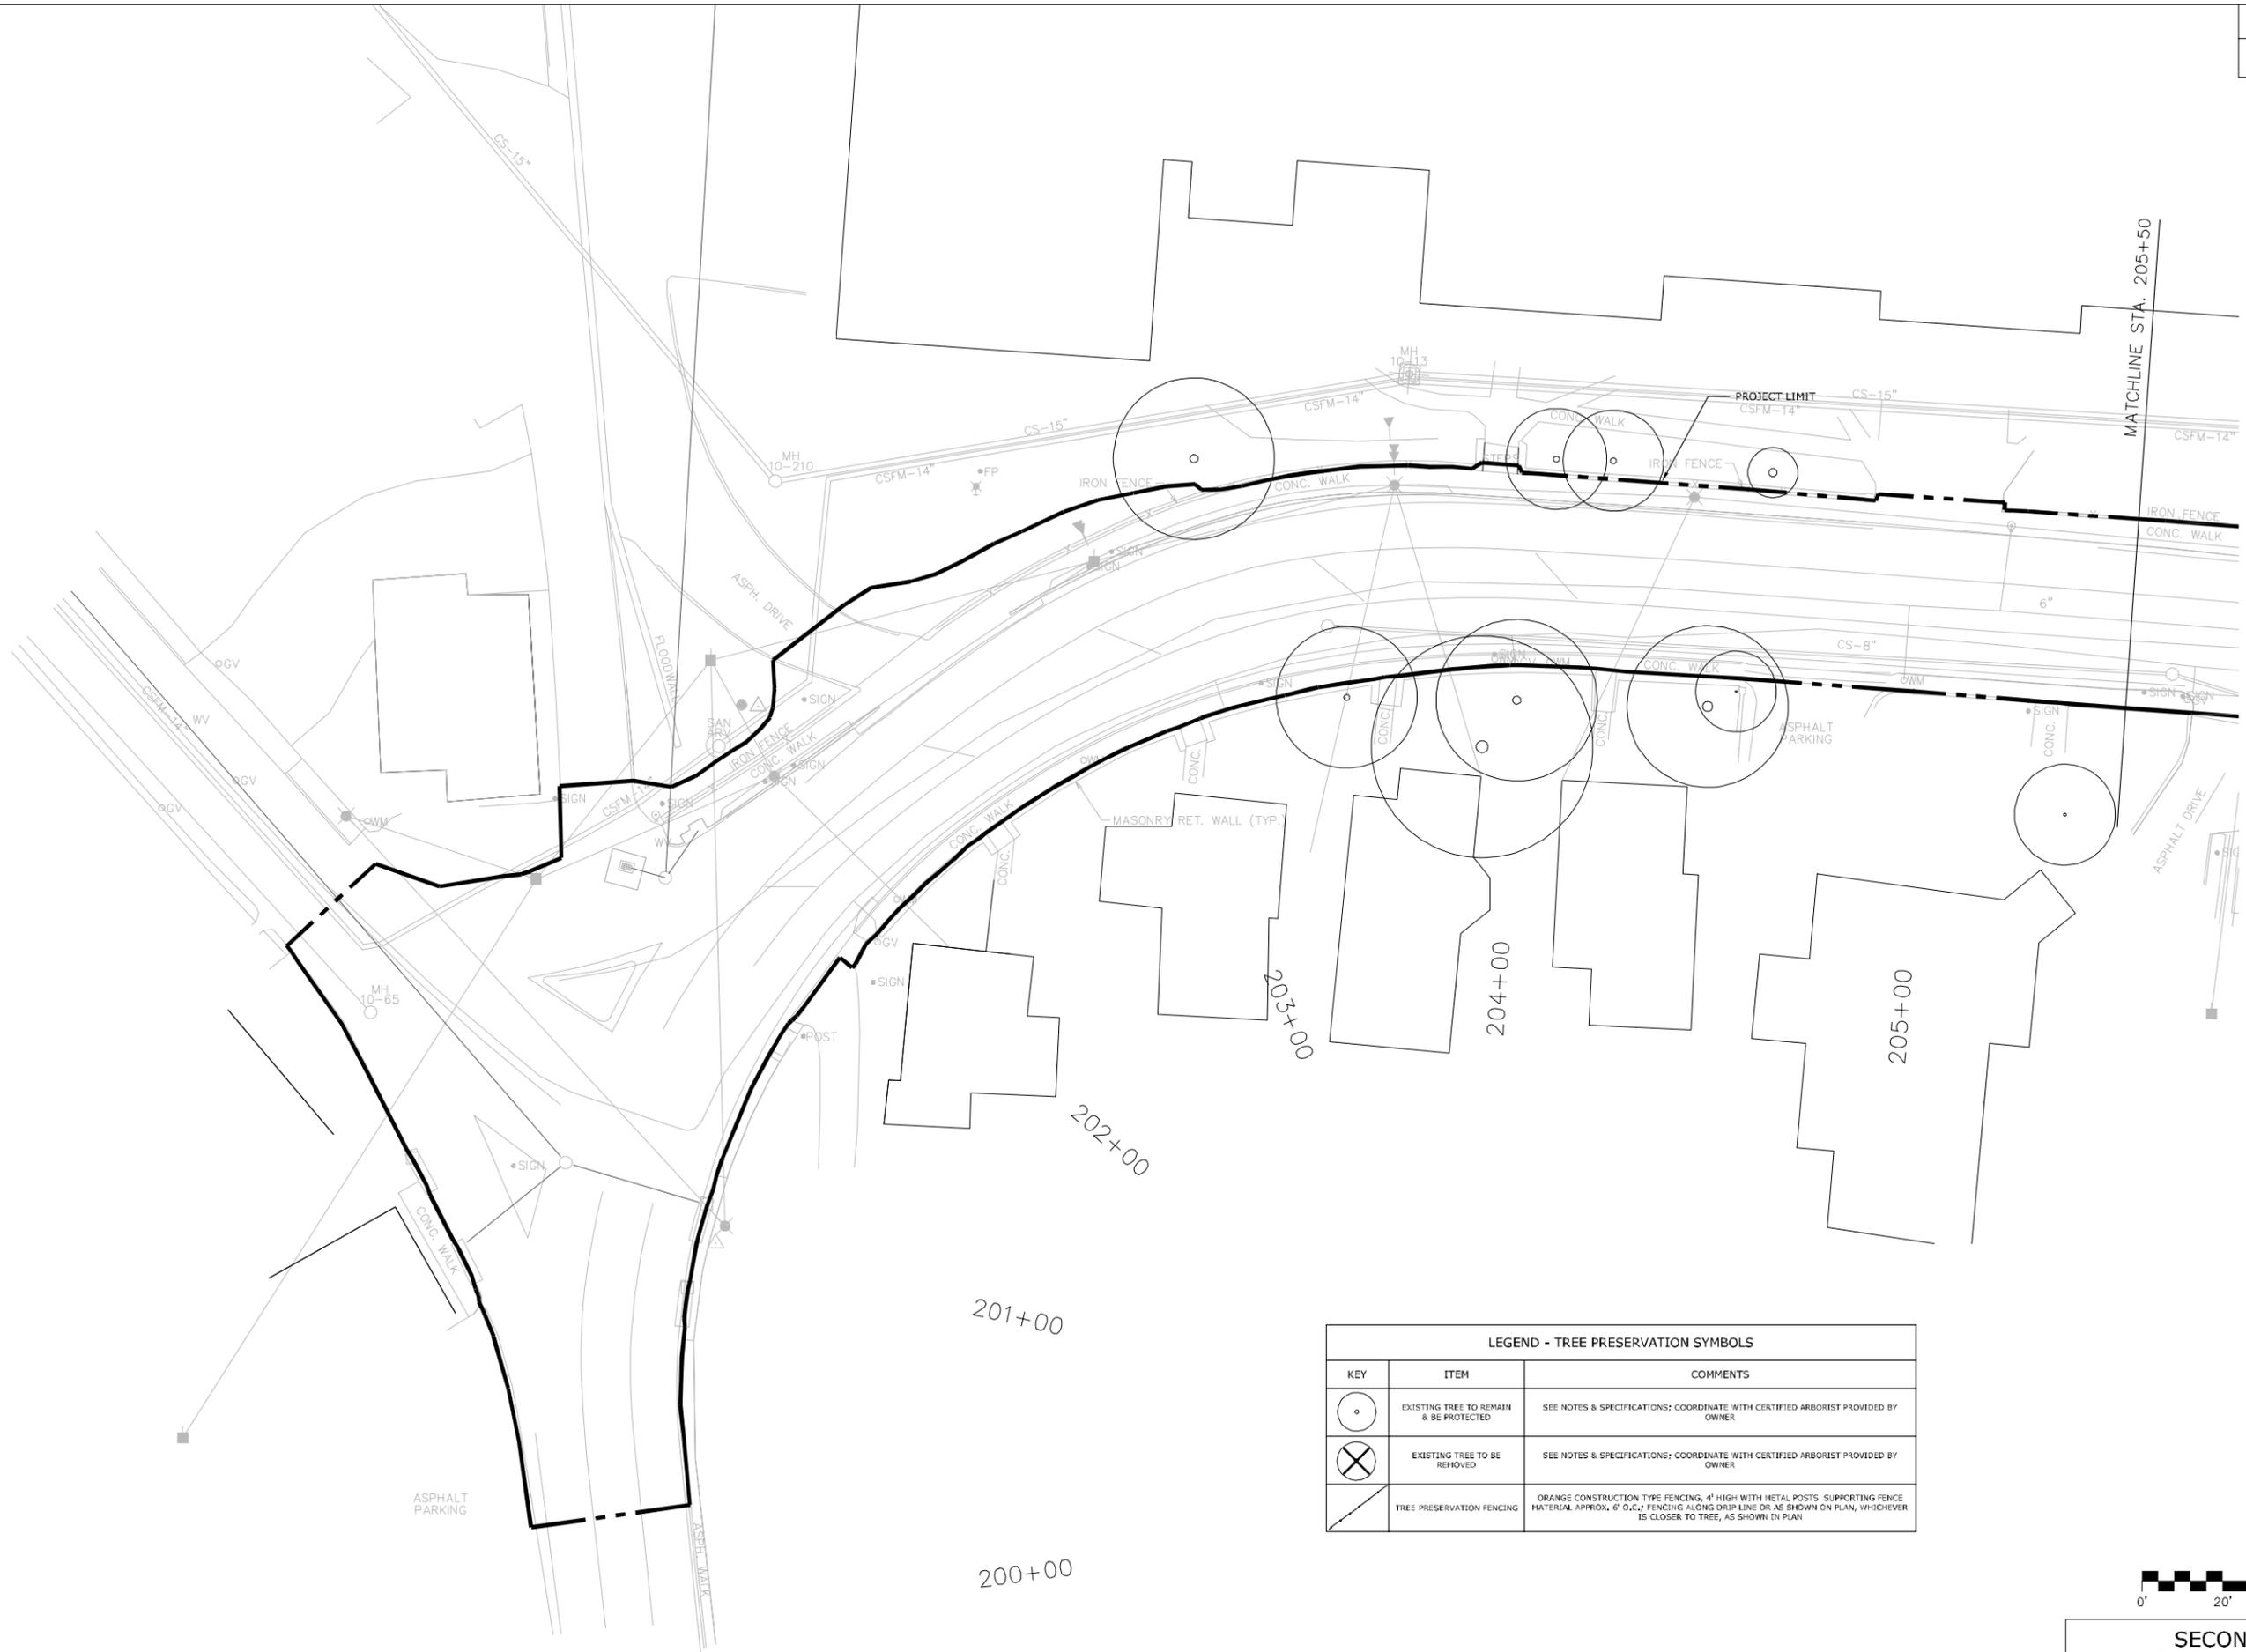



LEGEND - TREE PRESERVATION SYMBOLS		
KEY	ITEM	COMMENTS
	EXISTING TREE TO REMAIN & BE PROTECTED	SEE NOTES & SPECIFICATIONS; COORDINATE WITH CERTIFIED ARBORIST PROVIDED BY OWNER
	EXISTING TREE TO BE REMOVED	SEE NOTES & SPECIFICATIONS; COORDINATE WITH CERTIFIED ARBORIST PROVIDED BY OWNER
	TREE PRESERVATION FENCING	ORANGE CONSTRUCTION TYPE FENCING, 4' HIGH WITH METAL POSTS. SUPPORTING FENCE MATERIAL APPROX. 6' O.C.; FENCING ALONG DRIP LINE OR AS SHOWN ON PLAN, WHICHEVER IS CLOSER TO TREE, AS SHOWN IN PLAN



SCALE: 1"=20'

SECOND STREET (US 60)
BEGINNING TO STA.205+50
TREE PROTECTION PLAN - AREA 1



LEGEND - TREE PRESERVATION SYMBOLS		
KEY	ITEM	COMMENTS
	EXISTING TREE TO REMAIN & BE PROTECTED	SEE NOTES & SPECIFICATIONS; COORDINATE WITH CERTIFIED ARBORIST PROVIDED BY OWNER
	EXISTING TREE TO BE REMOVED	SEE NOTES & SPECIFICATIONS; COORDINATE WITH CERTIFIED ARBORIST PROVIDED BY OWNER
	TREE PRESERVATION FENCING	ORANGE CONSTRUCTION TYPE FENCING, 4' HIGH WITH METAL POSTS SUPPORTING FENCE MATERIAL APPROX. 6" O.C.; FENCING ALONG DRIP LINE OR AS SHOWN ON PLAN, WHICHEVER IS CLOSER TO TREE, AS SHOWN IN PLAN

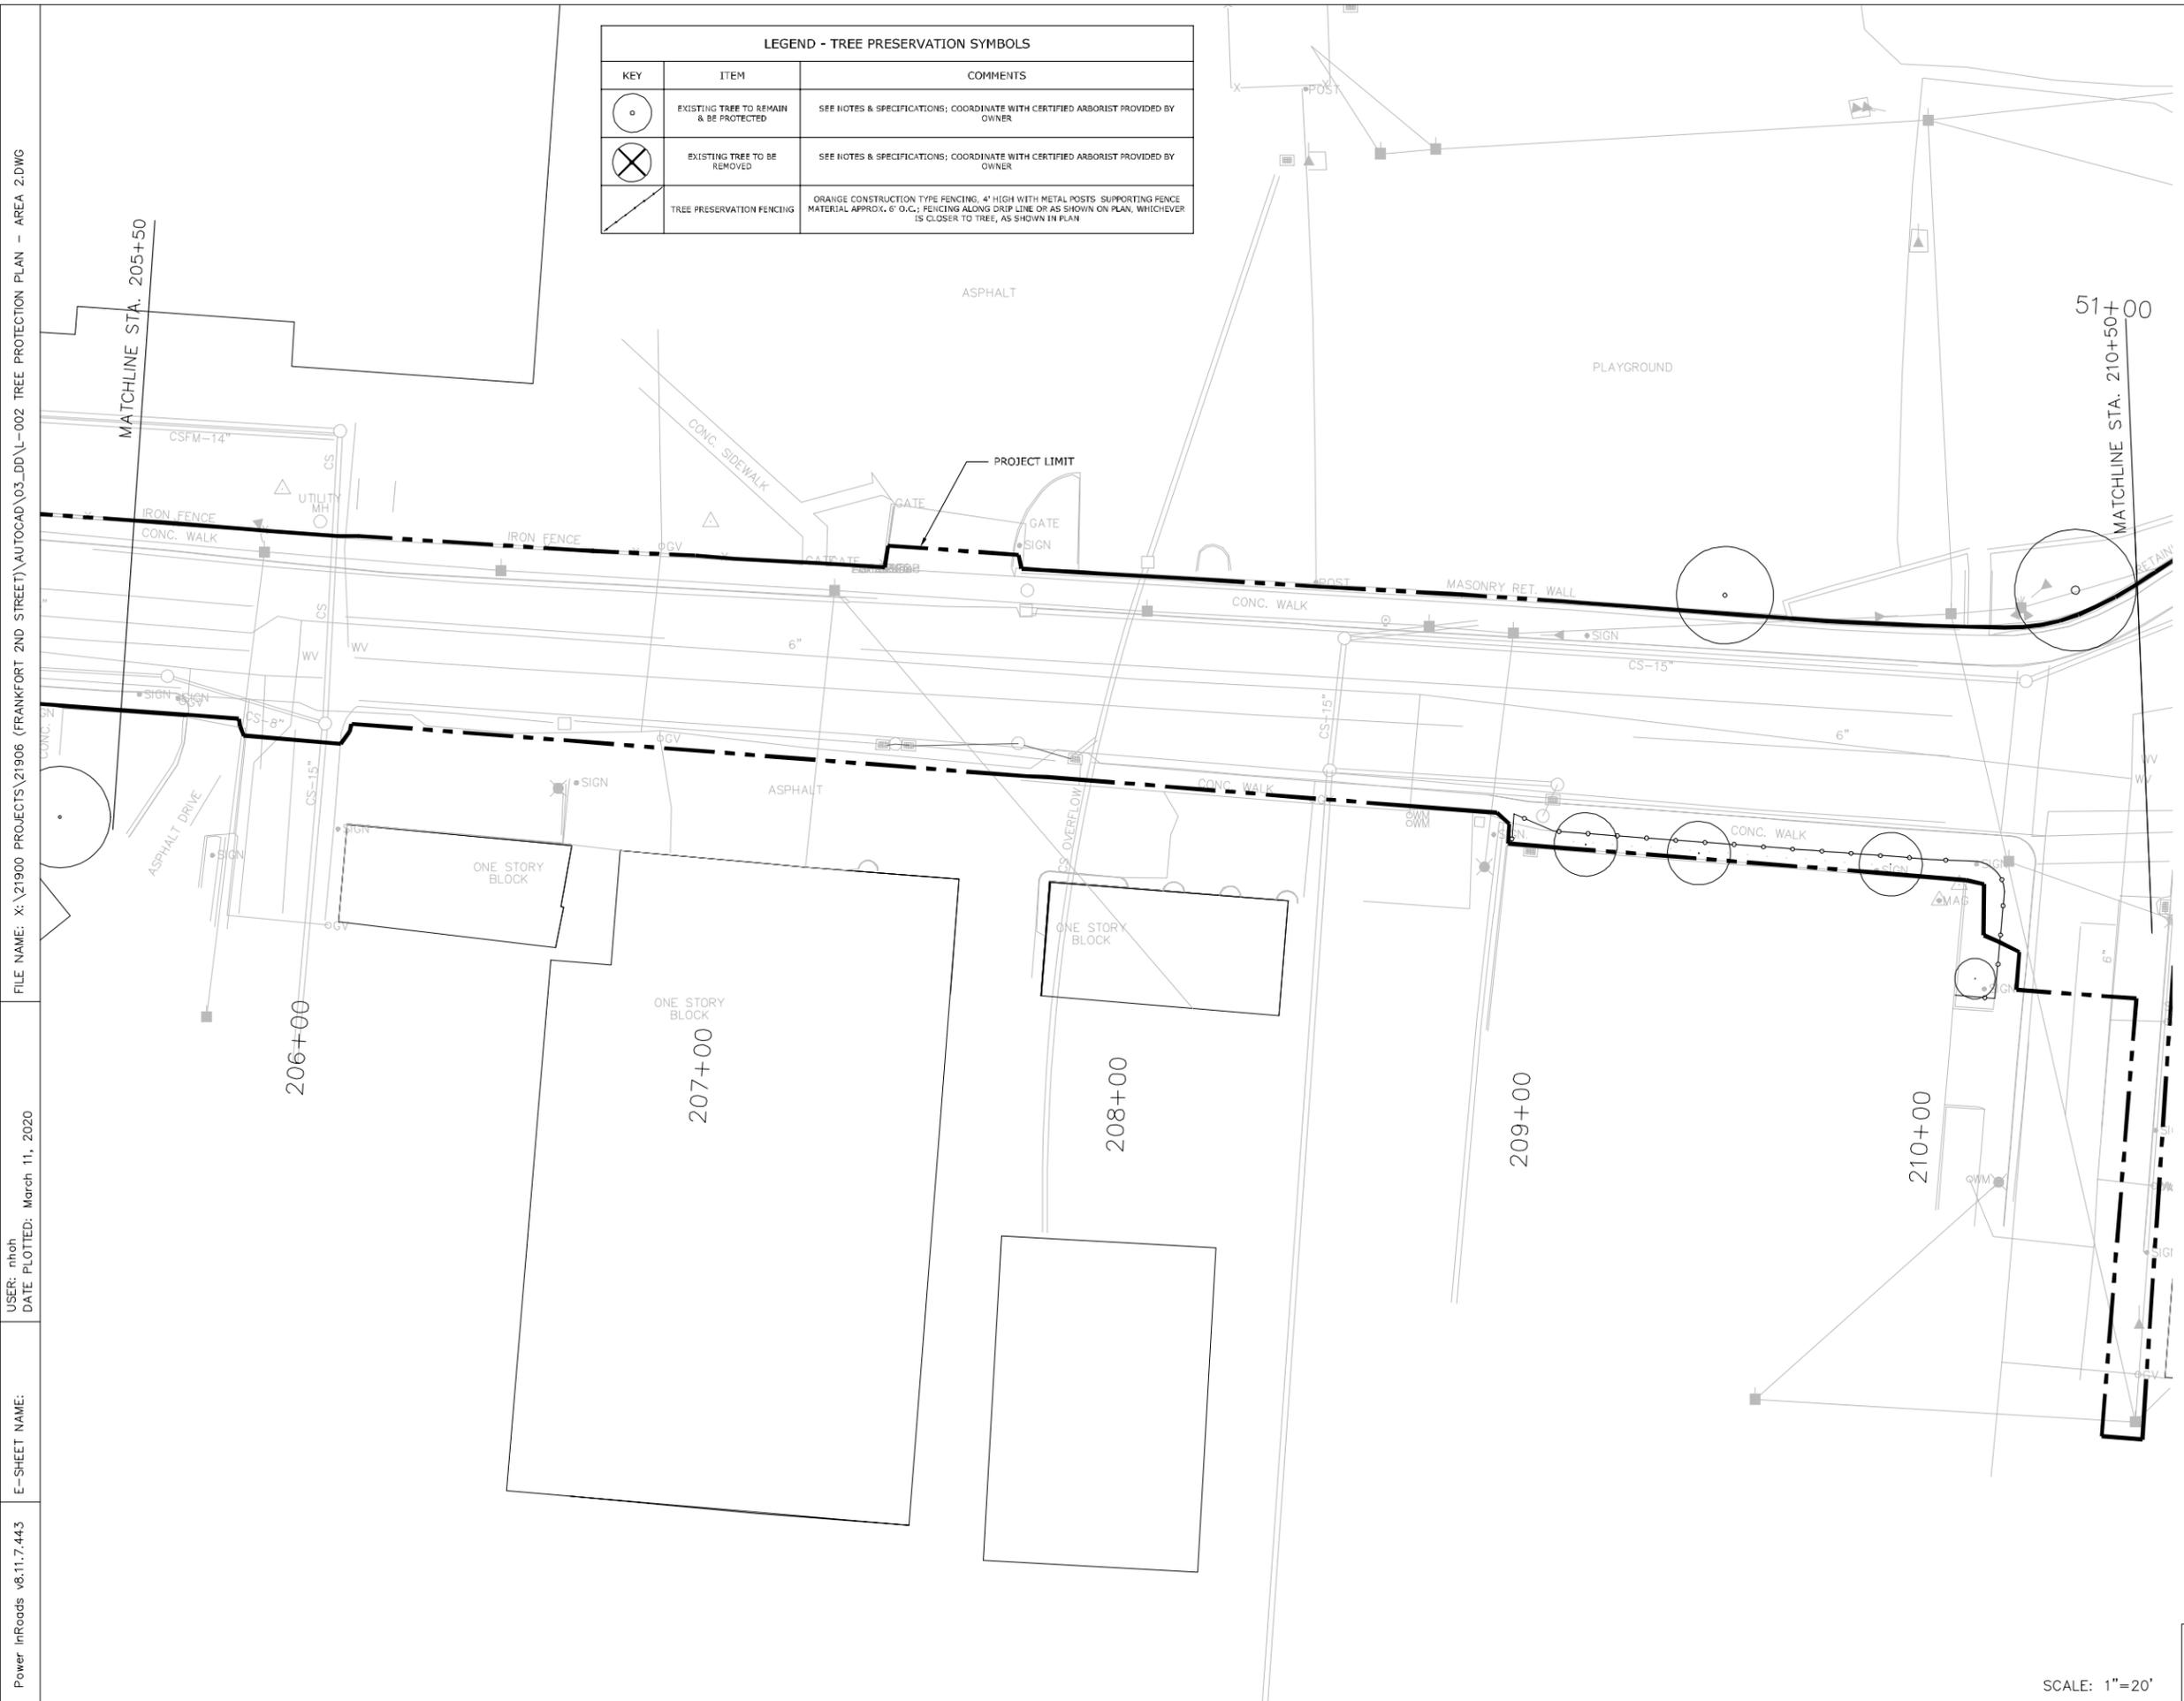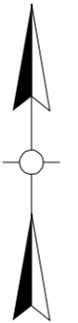

SCALE: 1"=20'
SECOND STREET (US 60)
STA. 205+50 TO STA. 210+50
TREE PROTECTION PLAN - AREA 2

Power InRoads v8.11.7.443 E-SHEET NAME: USER: nfhoh DATE PLOTTED: March 11, 2020 FILE NAME: X:\21900 PROJECTS\21906 (FRANKFORT 2ND STREET)\AUTOCAD\03_DD\L-002 TREE PROTECTION PLAN - AREA 2.DWG


LEGEND - TREE PRESERVATION SYMBOLS		
KEY	ITEM	COMMENTS
	EXISTING TREE TO REMAIN & BE PROTECTED	SEE NOTES & SPECIFICATIONS; COORDINATE WITH CERTIFIED ARBORIST PROVIDED BY OWNER
	EXISTING TREE TO BE REMOVED	SEE NOTES & SPECIFICATIONS; COORDINATE WITH CERTIFIED ARBORIST PROVIDED BY OWNER
	TREE PRESERVATION FENCING	ORANGE CONSTRUCTION TYPE FENCING, 4' HIGH WITH METAL POSTS SUPPORTING FENCE MATERIAL APPROX. 6' O.C.; FENCING ALONG DRIP LINE OR AS SHOWN ON PLAN, WHICHEVER IS CLOSER TO TREE, AS SHOWN IN PLAN

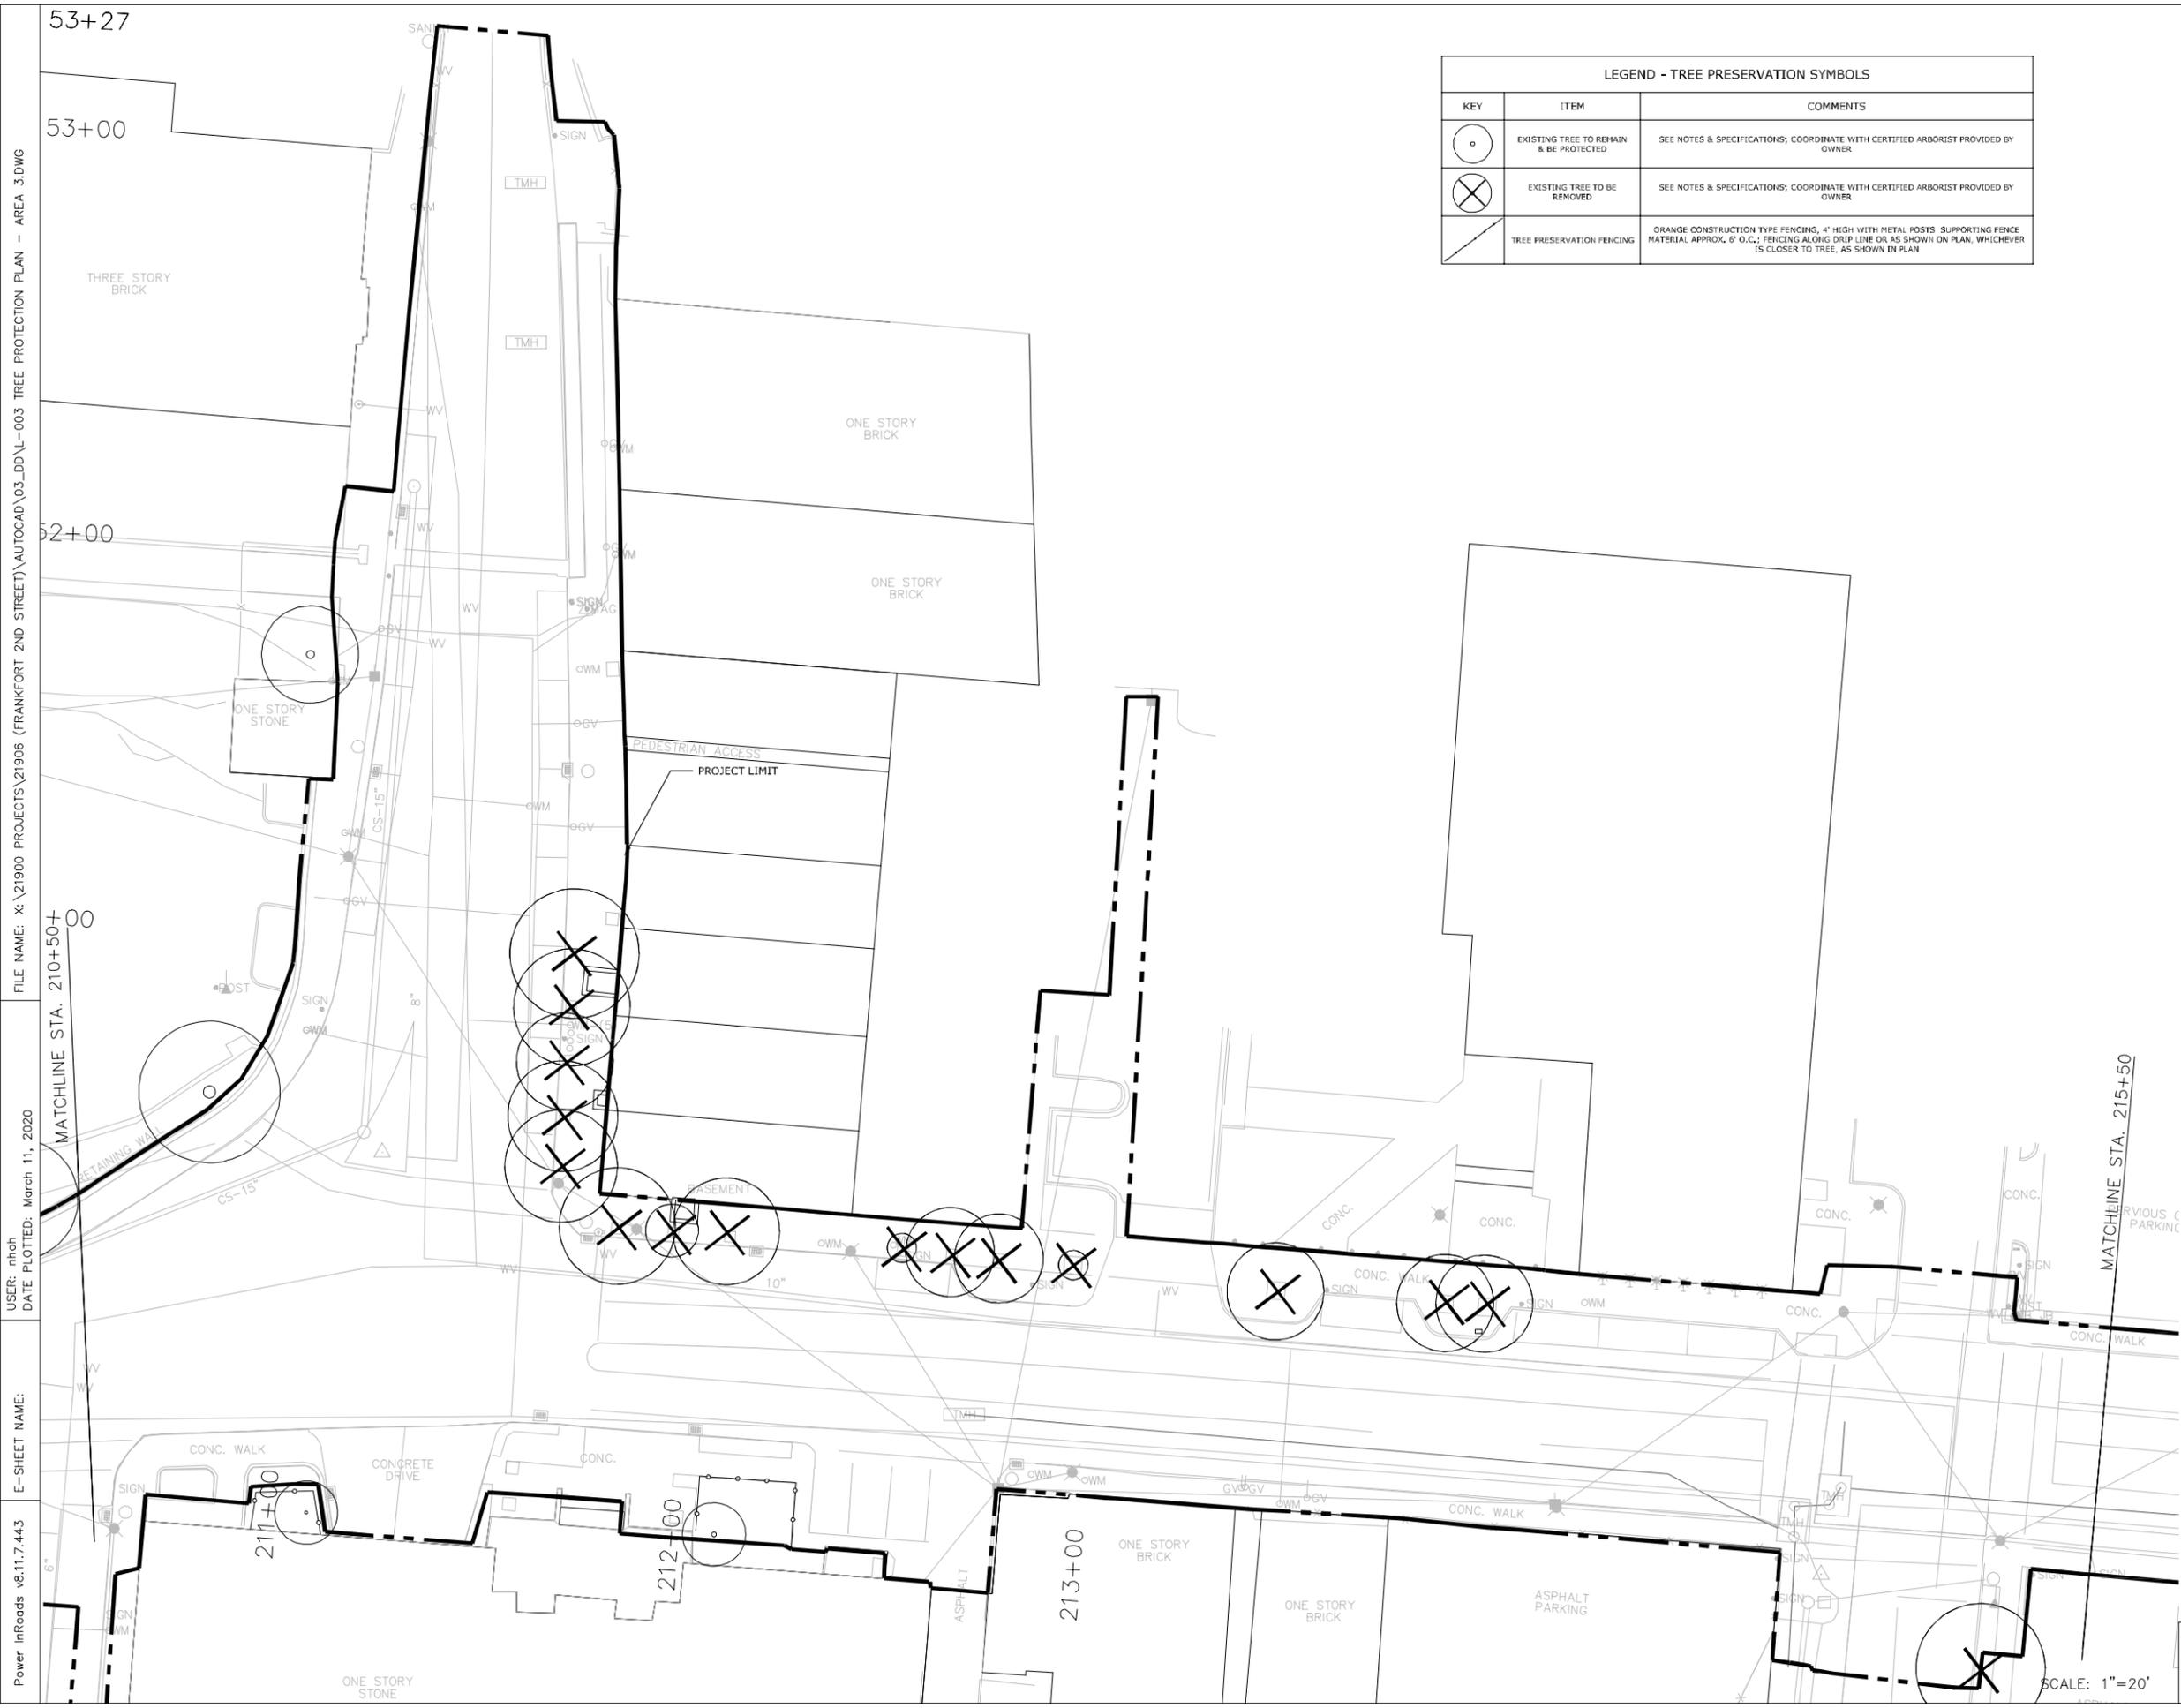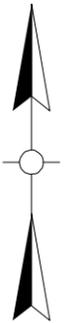


SECOND STREET (US 60) STA. 210+50 TO STA. 215+50 & BRIDGE STREET
 TREE PROTECTION PLAN - AREA 3

FILE NAME: X:\21900 PROJECTS\21906 (FRANKFORT 2ND STREET)\AUTOCAD\03.DD\L-003 TREE PROTECTION PLAN - AREA 3.DWG
 USER: nfh
 DATE PLOTTED: March 11, 2020
 E-SHEET NAME: Power InRoads v8.11.7.443

LEGEND - TREE PRESERVATION SYMBOLS		
KEY	ITEM	COMMENTS
	EXISTING TREE TO REMAIN & BE PROTECTED	SEE NOTES & SPECIFICATIONS; COORDINATE WITH CERTIFIED ARBORIST PROVIDED BY OWNER
	EXISTING TREE TO BE REMOVED	SEE NOTES & SPECIFICATIONS; COORDINATE WITH CERTIFIED ARBORIST PROVIDED BY OWNER
	TREE PRESERVATION FENCING	ORANGE CONSTRUCTION TYPE FENCING, 4' HIGH WITH METAL POSTS. SUPPORTING FENCE MATERIAL APPROX. 6" O.C.; FENCING ALONG DRIP LINE OR AS SHOWN ON PLAN, WHICHEVER IS CLOSER TO TREE, AS SHOWN IN PLAN

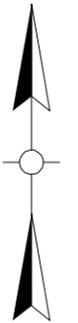


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 USER: nhh
 DATE PLOTTED: March 11, 2020
 E-SHEET NAME:
 Power InRoads v8.11.7.443

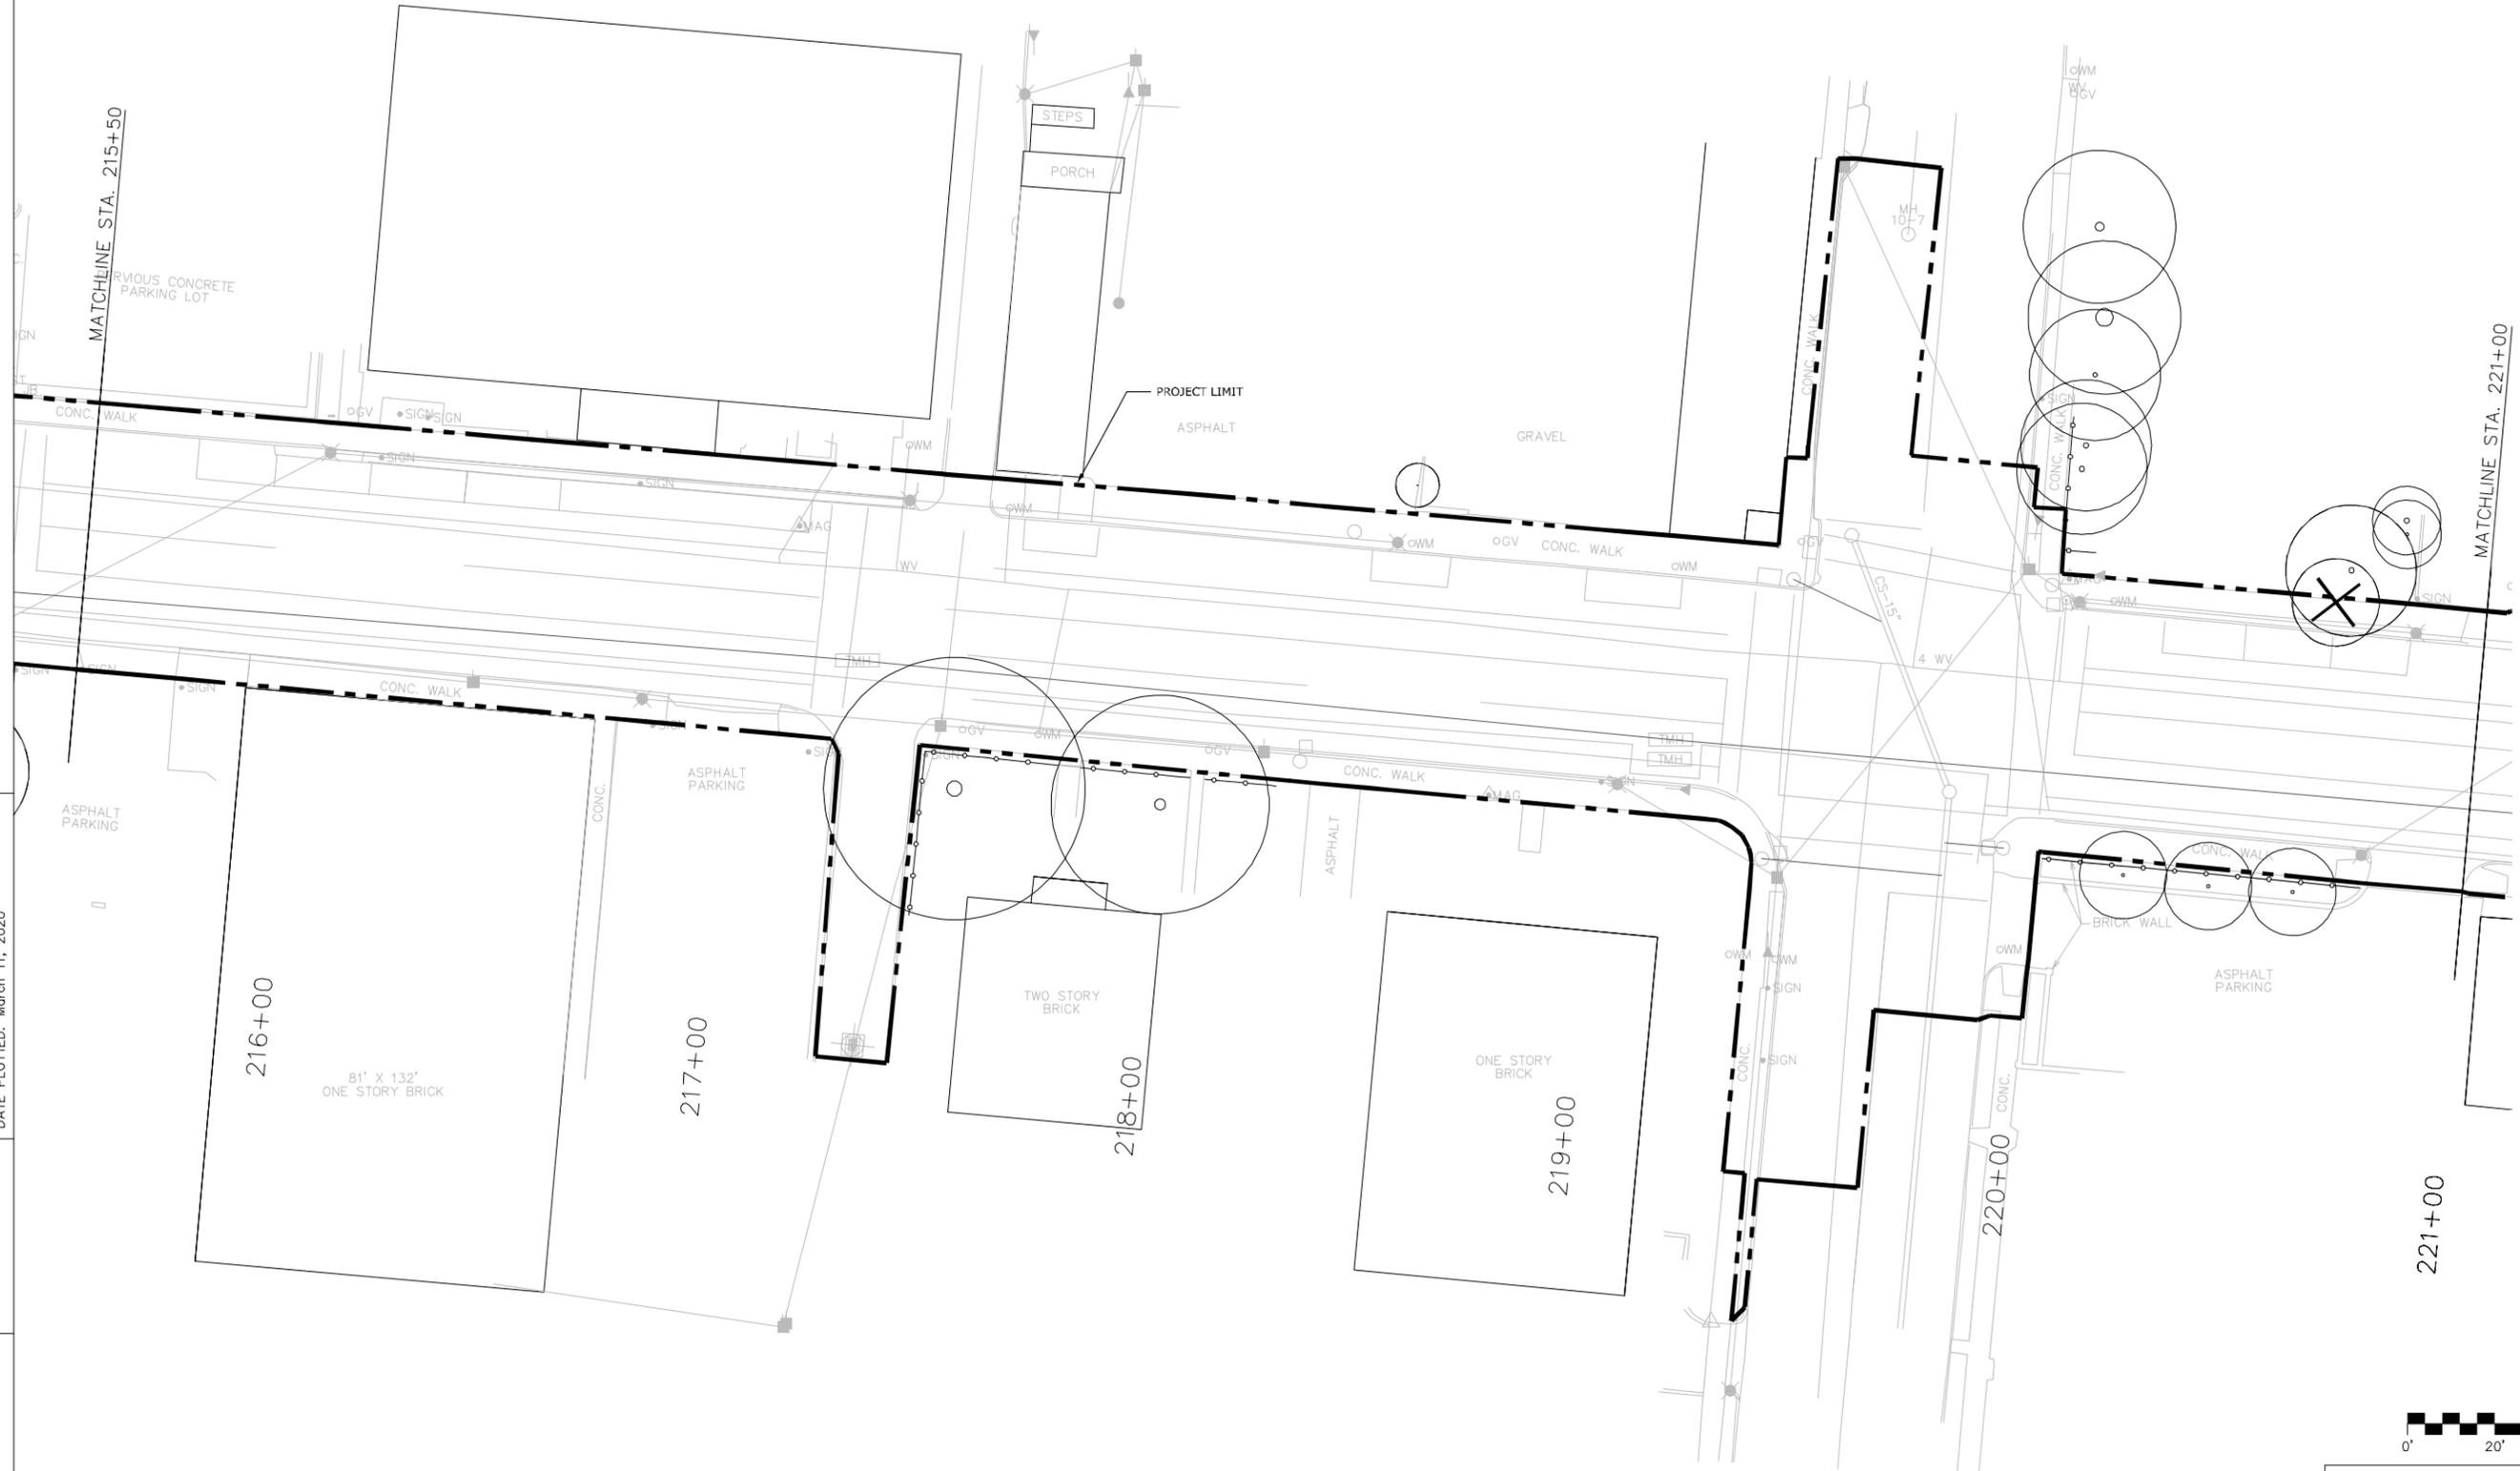

SCALE: 1"=20'
 SECOND STREET (US 60)
 STA. 215+50 TO STA. 221+00
 TREE PROTECTION PLAN - AREA 4

LEGEND - TREE PRESERVATION SYMBOLS		
KEY	ITEM	COMMENTS
	EXISTING TREE TO REMAIN & BE PROTECTED	SEE NOTES & SPECIFICATIONS; COORDINATE WITH CERTIFIED ARBORIST PROVIDED BY OWNER
	EXISTING TREE TO BE REMOVED	SEE NOTES & SPECIFICATIONS; COORDINATE WITH CERTIFIED ARBORIST PROVIDED BY OWNER
	TREE PRESERVATION FENCING	ORANGE CONSTRUCTION TYPE FENCING, 4' HIGH WITH METAL POSTS. SUPPORTING FENCE MATERIAL APPROX. 6" O.C.; FENCING ALONG DRIP LINE OR AS SHOWN ON PLAN, WHICHEVER IS CLOSER TO TREE, AS SHOWN IN PLAN

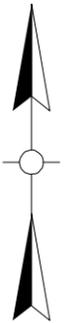


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 USER: mhoh
 DATE PLOTTED: March 11, 2020
 E-SHEET NAME:
 Power InRoads v8.11.7.443



SECOND STREET (US 60)
 STA. 221+00 TO END & CAPITAL AVE
 TREE PROTECTION PLAN - AREA 5



SCALE: 1"=20'

FILE NAME: X:\21900 PROJECTS\21906 (FRANKFORT 2ND STREET)\AUTOCAD\03.DD\L-006 TREE PROTECTION PLAN - AREA 6 & 7.DWG
 USER: nfh
 DATE PLOTTED: March 11, 2020
 E-SHEET NAME:
 Power InRoads v8.11.7.443

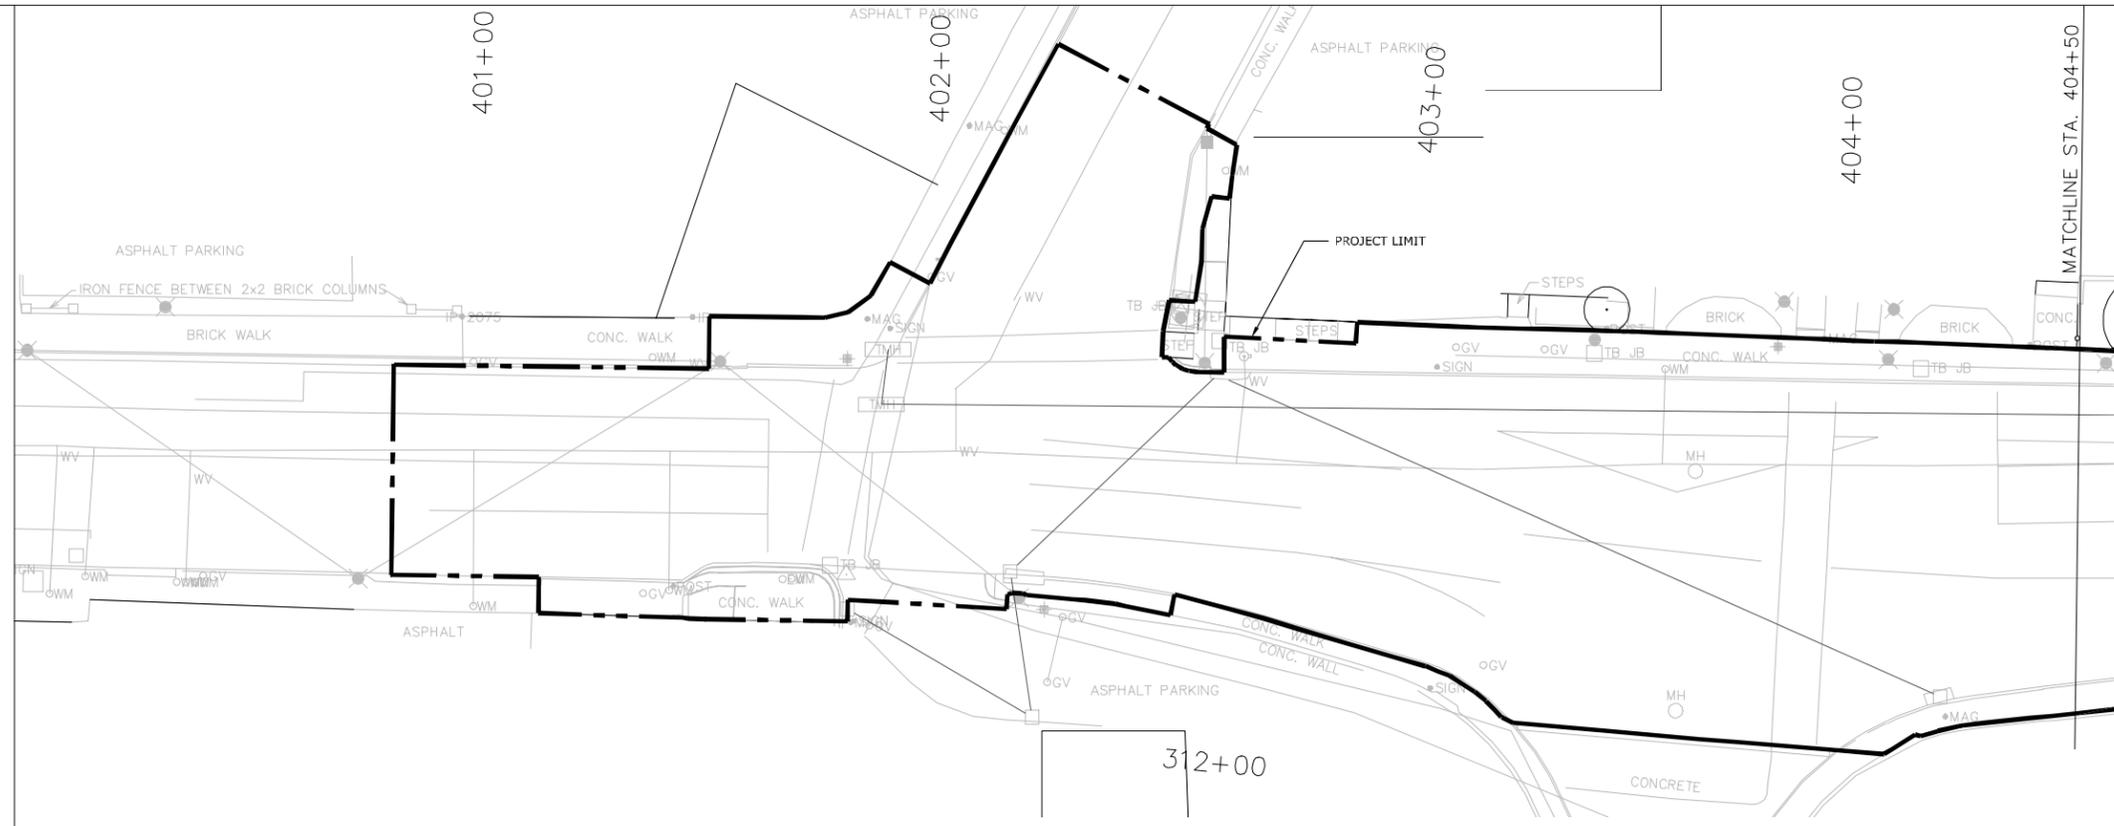

1 MAIN STREET (BEGINNING TO STA. 404+50)
SCALE: 1" = 20'

LEGEND - TREE PRESERVATION SYMBOLS		
KEY	ITEM	COMMENTS
	EXISTING TREE TO REMAIN & BE PROTECTED	SEE NOTES & SPECIFICATIONS; COORDINATE WITH CERTIFIED ARBORIST PROVIDED BY OWNER
	EXISTING TREE TO BE REMOVED	SEE NOTES & SPECIFICATIONS; COORDINATE WITH CERTIFIED ARBORIST PROVIDED BY OWNER
	TREE PRESERVATION FENCING	ORANGE CONSTRUCTION TYPE FENCING, 4' HIGH WITH METAL POSTS. SUPPORTING FENCE MATERIAL APPROX. 6" O.C.; FENCING ALONG DRIP LINE OR AS SHOWN ON PLAN, WHICHEVER IS CLOSER TO TREE, AS SHOWN IN PLAN

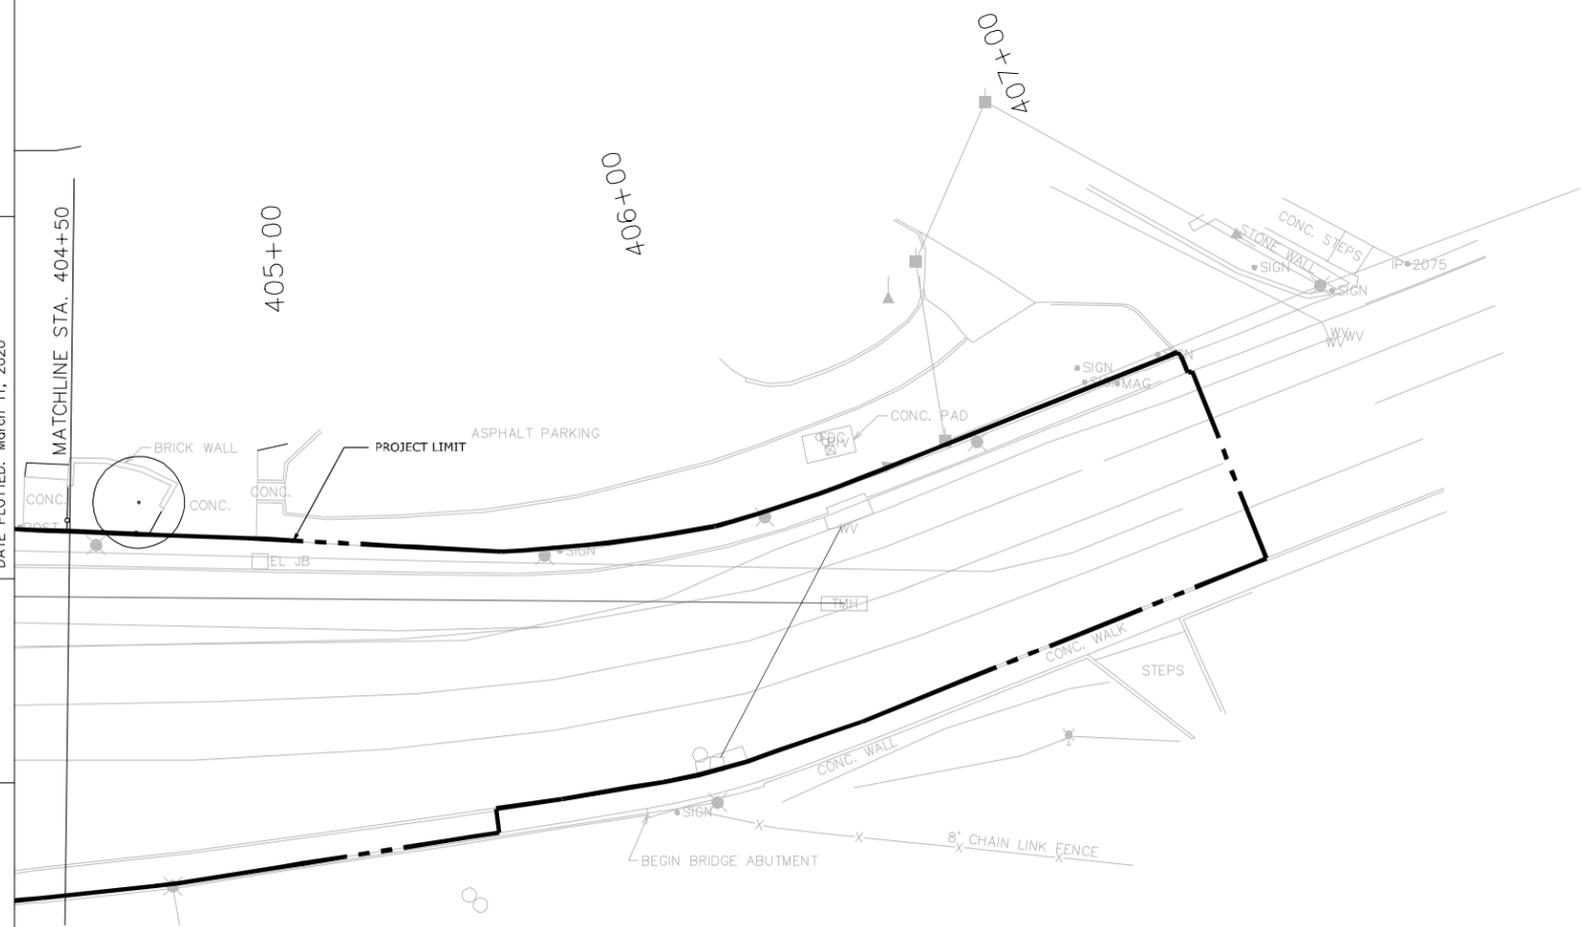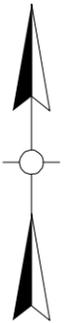

2 MAIN STREET (STA. 404+50 TO END.)
SCALE: 1" = 20'




FILE NAME: X:\21900 PROJECTS\21906 (FRANKFORT 2ND STREET)\AUTOCAD\03_DD\L-100 HARDSCAPE & MATERIALS PLAN OVERVIEW.DWG
 USER: kyon
 DATE PLOTTED: March 11, 2020
 E-SHEET NAME:
 Power InRoads v8.11.7.443

COUNTY OF	ITEM NO.	SHEET NO.
FRANKLIN	5-565	L-100

HARDSCAPE MATERIAL SCHEDULE


KEY	ITEM	SUPPLIER (BASIS OF DESIGN OR APPROVED EQUAL)	NOTES
	CONCRETE TYPE 1, SIDEWALK & MULTI-USE PATH	N/A	5" THICK CONCRETE. BROOM FINISH PERPENDICULAR TO FLOW OF TRAFFIC; UNLESS OTHERWISE NOTED, TOOLED JOINTS & EDGES; NO EDGE MARKS FINISH TO MATCH ADJACENT SIDEWALK AND CURB
	CONCRETE TYPE 2, DRIVEWAY, CURB CUT	N/A	8" THICK CONCRETE. DETAILS SEE CIVIL DRAWINGS. JOINTS AND SCORING TO BE CONSISTENT FOR SIDEWALK / MULTI-USE PATH
	POROUS PAVEMENT	SEE CIVIL DRAWING	POROUS CONCRETE
	PAVERS; CLAY; 2.25" THICK	BELDEN BRICK (330)-451-2031 www.beldenbrick.com	PAWNEE PAVER A (PAWNEE RED PAVER A), RUNNING BOND. VARIES, SEE DETAILS ON ENLARGEMENTS ON L-107
	ADA TRUNCATED DOME PLATE	1) EJ GROUP. INC. 1855 FEDDERN AVE, GROVE CITY, OH 43123 614.871.2436 WWW.EJCO.COM 2) NEENAH FOUNDRY 2121 Brooks Ave, Neenah, WI 54956 www.nfco.com 3) ADVANTAGE TACTILE SYSTEMS Robert Wickline (KENTUCKY) 347-278-7729 advantagetactile.com	FOR EJ GROUP, INC. DETECTABLE WARNING PLATES, COLOR: UNPAINTED PLATES CAST GRAY IRON, QUICK CONNECT PLATES (PRODUCT NO. 00700571, NO. 00700561) INSTALLED AT ALL FLAT CURBS, RADIUS PLATES (PRODUCT NO. 00700611, NO. 00700615, NO. 00700621, NO. 00700625, NO. 00700635) INSTALLED AT ALL RADIAL CURB CONDITIONS; RADIAL PLATES TO MATCH RADIUS OF CURB; UNLESS OTHERWISE NOTED. SEE SPECIFICATIONS FOR ADDITIONAL REQUIREMENTS.
	MULTI-USE PATH STENCIL	N/A	2X2' FACING PEDESTRIAN / BICYCLE TRAFFIC FLOW. SANDBLASTED ON CONCRETE. LOCATION AS MARKED ON PLAN. SEE DETAIL 3/L-108
	INSET ART ON PAVEMENT	N/A	3X2', NARRATIVE FACING IN FRONT OF THE BUILDING. BRONZE. LOCATION AS MARKED ON PLAN. SEE DETAIL 4/L108

* SEE SPECIFICATIONS FOR ADDITIONAL INFORMATION AND REQUIREMENTS

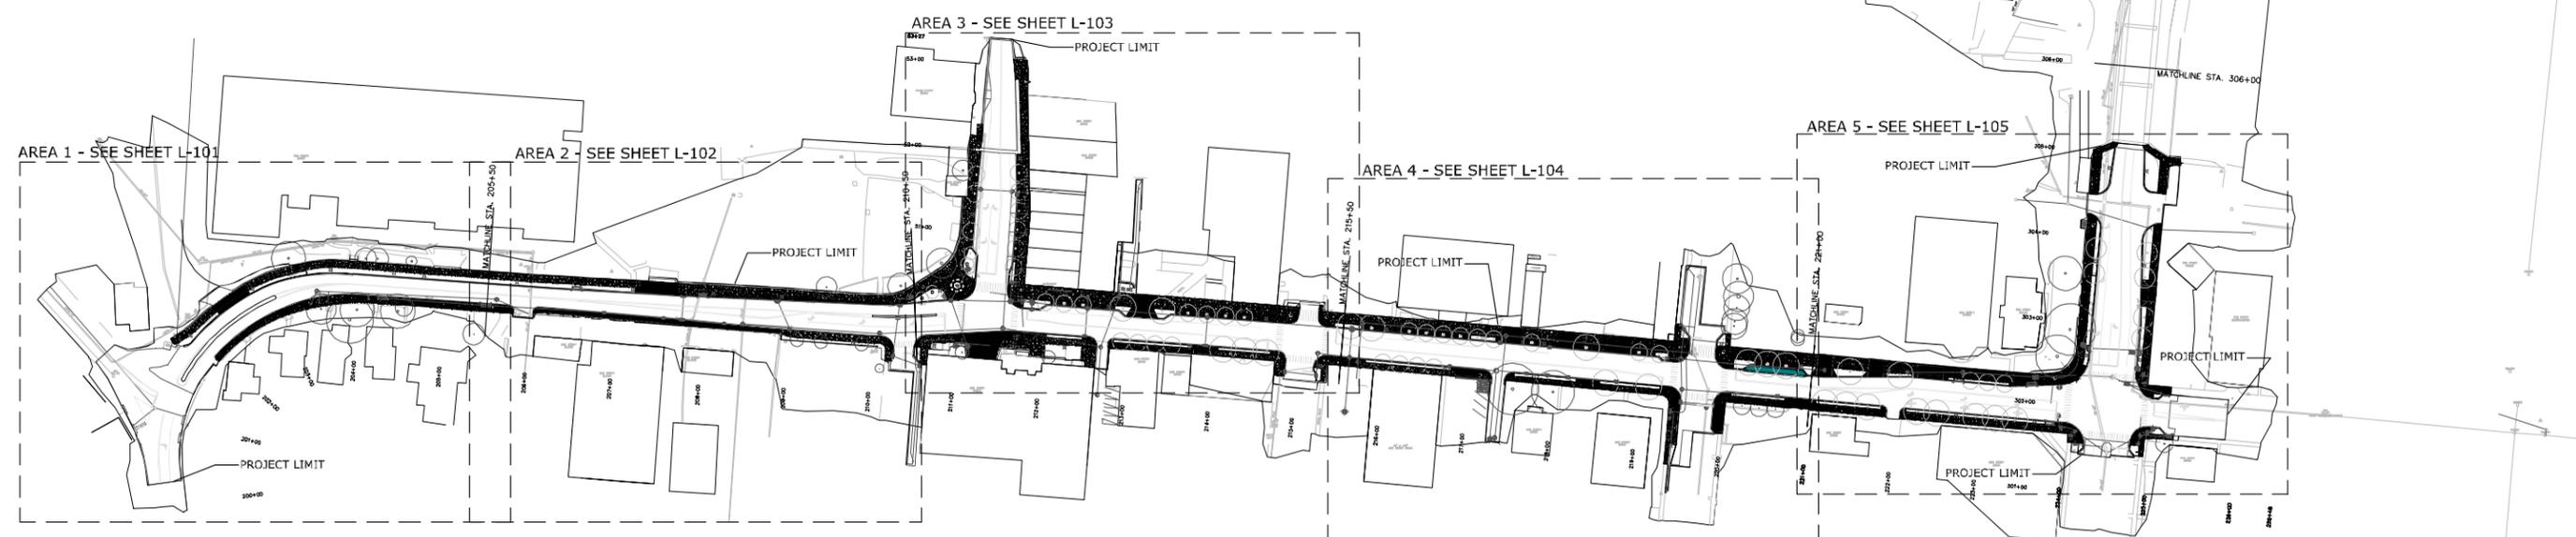

HARDSCAPE NOTES

- SEE CIVIL ENGINEER DRAWINGS FOR ALL PAVING CROSS SECTIONS AND BASE REQUIREMENTS.
- ALL ANGLES ARE 90° UNLESS OTHERWISE NOTED.
- 4'x4' MOCK-UP REQUIRED FOR ALL PAVING TYPES. MOCK-UP MAY ULTIMATELY BE PART OF FINISHED PAVED AREA IF APPROVED. SEE SPECIFICATIONS FOR ADDITIONAL REQUIREMENTS
- DIGITAL LAYOUT INFORMATION PROVIDED BY ENGINEER. SEE SITE GRADING AND LAYOUT SERIES FOR MORE INFORMATION.
- COORDINATE ALL SURFACE ELEMENTS OF ELECTRICAL UTILITIES & STORM DRAINAGE STRUCTURES WITH HARDSCAPE ELEMENTS; ALL ELECTRICAL AND STORM ELEMENTS SHOULD BE FLUSH WITH ADJACENT PAVEMENT; CONTRACTOR TO NOTIFY LANDSCAPE ARCHITECT OF ANY CONFLICTS AND RESOLVE ISSUES IN THE FIELD.
- SELECTIVE PRUNING OF EXISTING TREES WILL BE NEEDED ALONG STEPS, LANDINGS, AND WALLS; CONSULT LANDSCAPE ARCHITECT & OWNERS REP. PRIOR TO PRUNING TREES FOR REVIEW AND APPROVAL
- THESE HARDSCAPE NOTES APPLY TO ALL "L-1XX" SERIES DRAWINGS

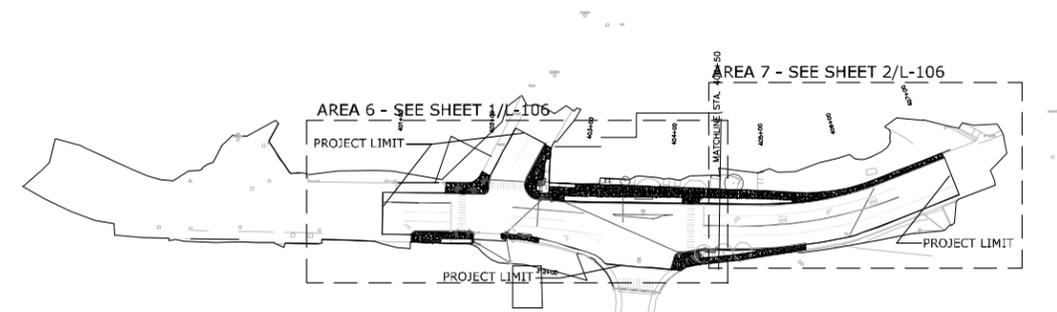

SCALE: 1"=100'



FRANKFORT SECOND STREET OVERALL PLAN HARDSCAPE & MATERIALS PLAN OVERVIEW

FILE NAME: X:\21900 PROJECTS\21906 (FRANKFORT 2ND STREET)\AUTOCAD\03_DD\L-101 HARDSCAPE & MATERIALS PLAN - AREA 1.DWG
 USER: kyon
 DATE PLOTTED: March 12, 2020
 E-SHEET NAME:
 Power InRoads v8.11.7.443

HARDSCAPE NOTES


1. SEE CIVIL ENGINEER DRAWINGS FOR ALL PAVING CROSS SECTIONS AND BASE REQUIREMENTS.
2. ALL ANGLES ARE 90° UNLESS OTHERWISE NOTED.
3. 4'x4' MOCK-UP REQUIRED FOR ALL PAVING TYPES. MOCK-UP MAY ULTIMATELY BE PART OF FINISHED PAVED AREA IF APPROVED. SEE SPECIFICATIONS FOR ADDITIONAL REQUIREMENTS
4. DIGITAL LAYOUT INFORMATION PROVIDED BY ENGINEER. SEE SITE GRADING AND LAYOUT SERIES FOR MORE INFORMATION.
5. COORDINATE ALL SURFACE ELEMENTS OF ELECTRICAL UTILITIES & STORM DRAINAGE STRUCTURES WITH HARDSCAPE ELEMENTS; ALL ELECTRICAL AND STORM ELEMENTS SHOULD BE FLUSH WITH ADJACENT PAVEMENT; CONTRACTOR TO NOTIFY LANDSCAPE ARCHITECT OF ANY CONFLICTS AND RESOLVE ISSUES IN THE FIELD.
6. SELECTIVE PRUNING OF EXISTING TREES WILL BE NEEDED ALONG STEPS, LANDINGS, AND WALLS; CONSULT LANDSCAPE ARCHITECT & OWNERS REP. PRIOR TO PRUNING TREES FOR REVIEW AND APPROVAL
7. THESE HARDSCAPE NOTES APPLY TO ALL "L-1XX" SERIES DRAWINGS

COUNTY OF	ITEM NO.	SHEET NO.
FRANKLIN	5-565	L-101

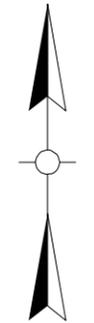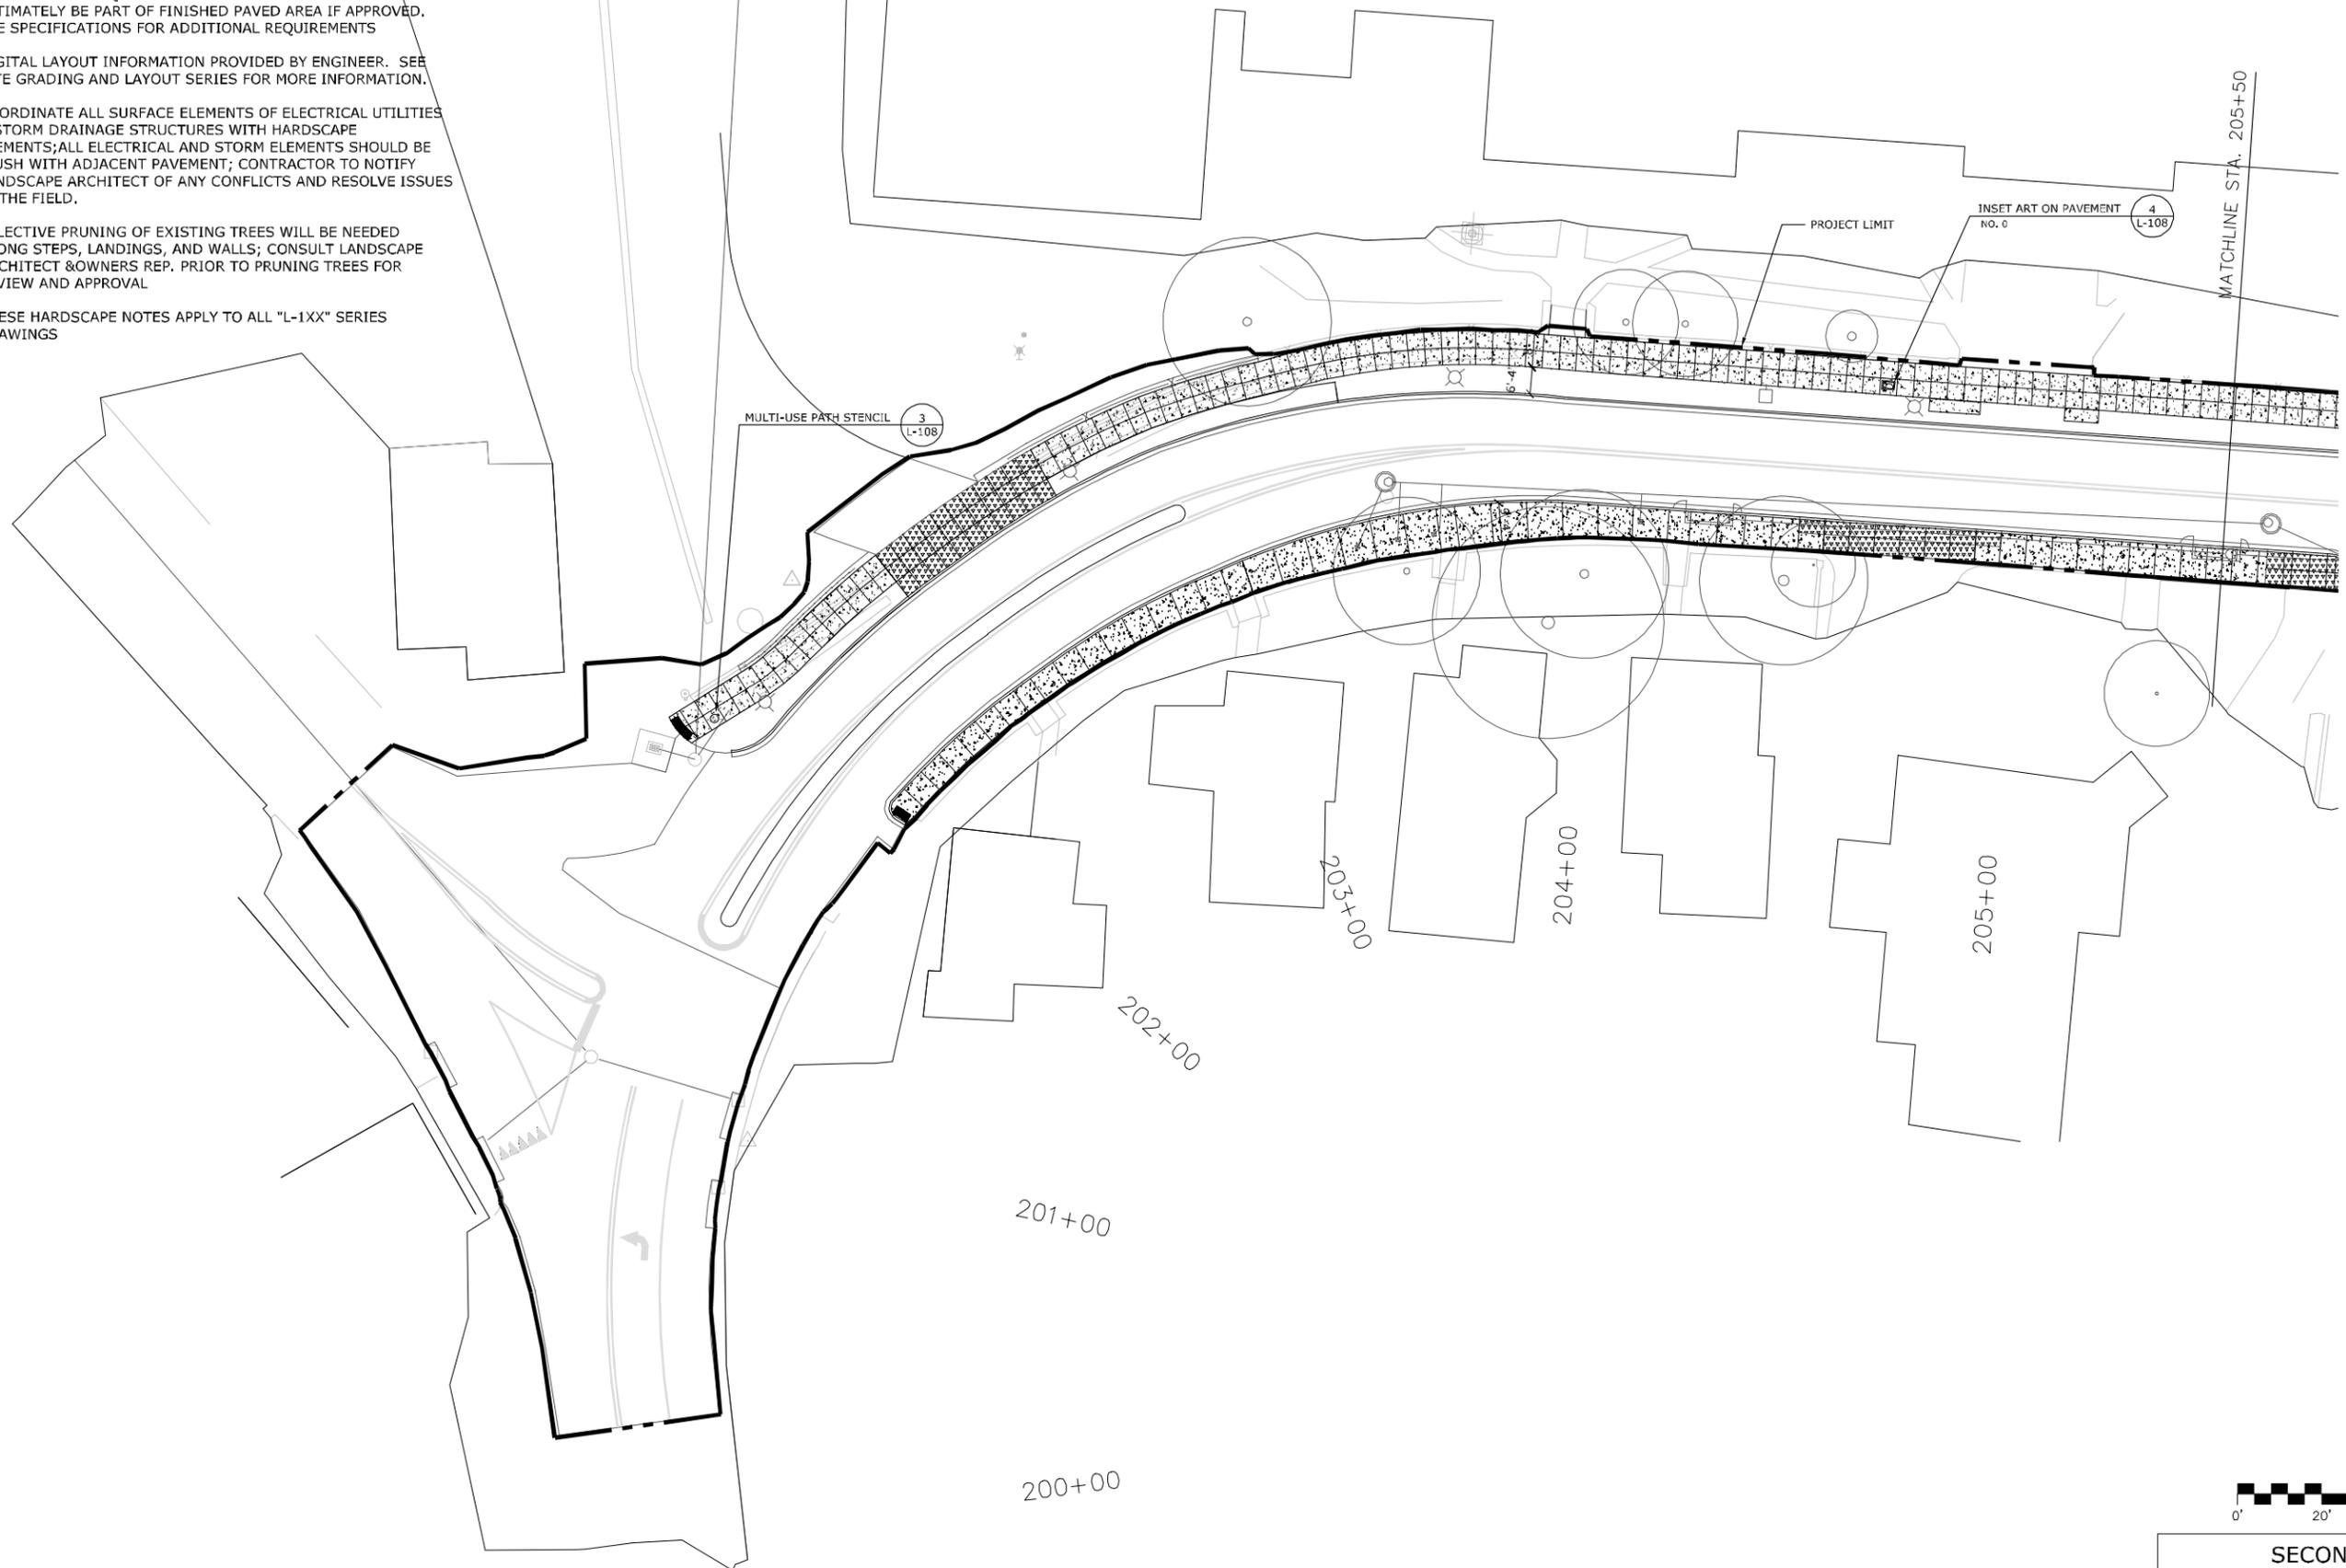



HARDSCAPE MATERIAL SCHEDULE	
KEY	ITEM
	CONCRETE TYPE 1, SIDEWALK & MULTI-USE PATH
	CONCRETE TYPE 2, DRIVEWAY, CURB CUT
	POROUS PAVEMENT
	PAVERS; CLAY; 2.25" THICK
	ADA TRUNCATED DOME PLATE
	MULTI-USE PATH STENCIL
	INSET ART ON PAVEMENT

* SEE SPECIFICATIONS FOR ADDITIONAL INFORMATION AND REQUIREMENTS

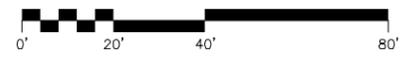

SCALE: 1"=20'
**SECOND STREET (US 60)
 BEGINNING TO STA.205+50
 HARDSCAPE & MATERIALS PLAN - AREA 1**

COUNTY OF	ITEM NO.	SHEET NO.
FRANKLIN	5-565	L-102

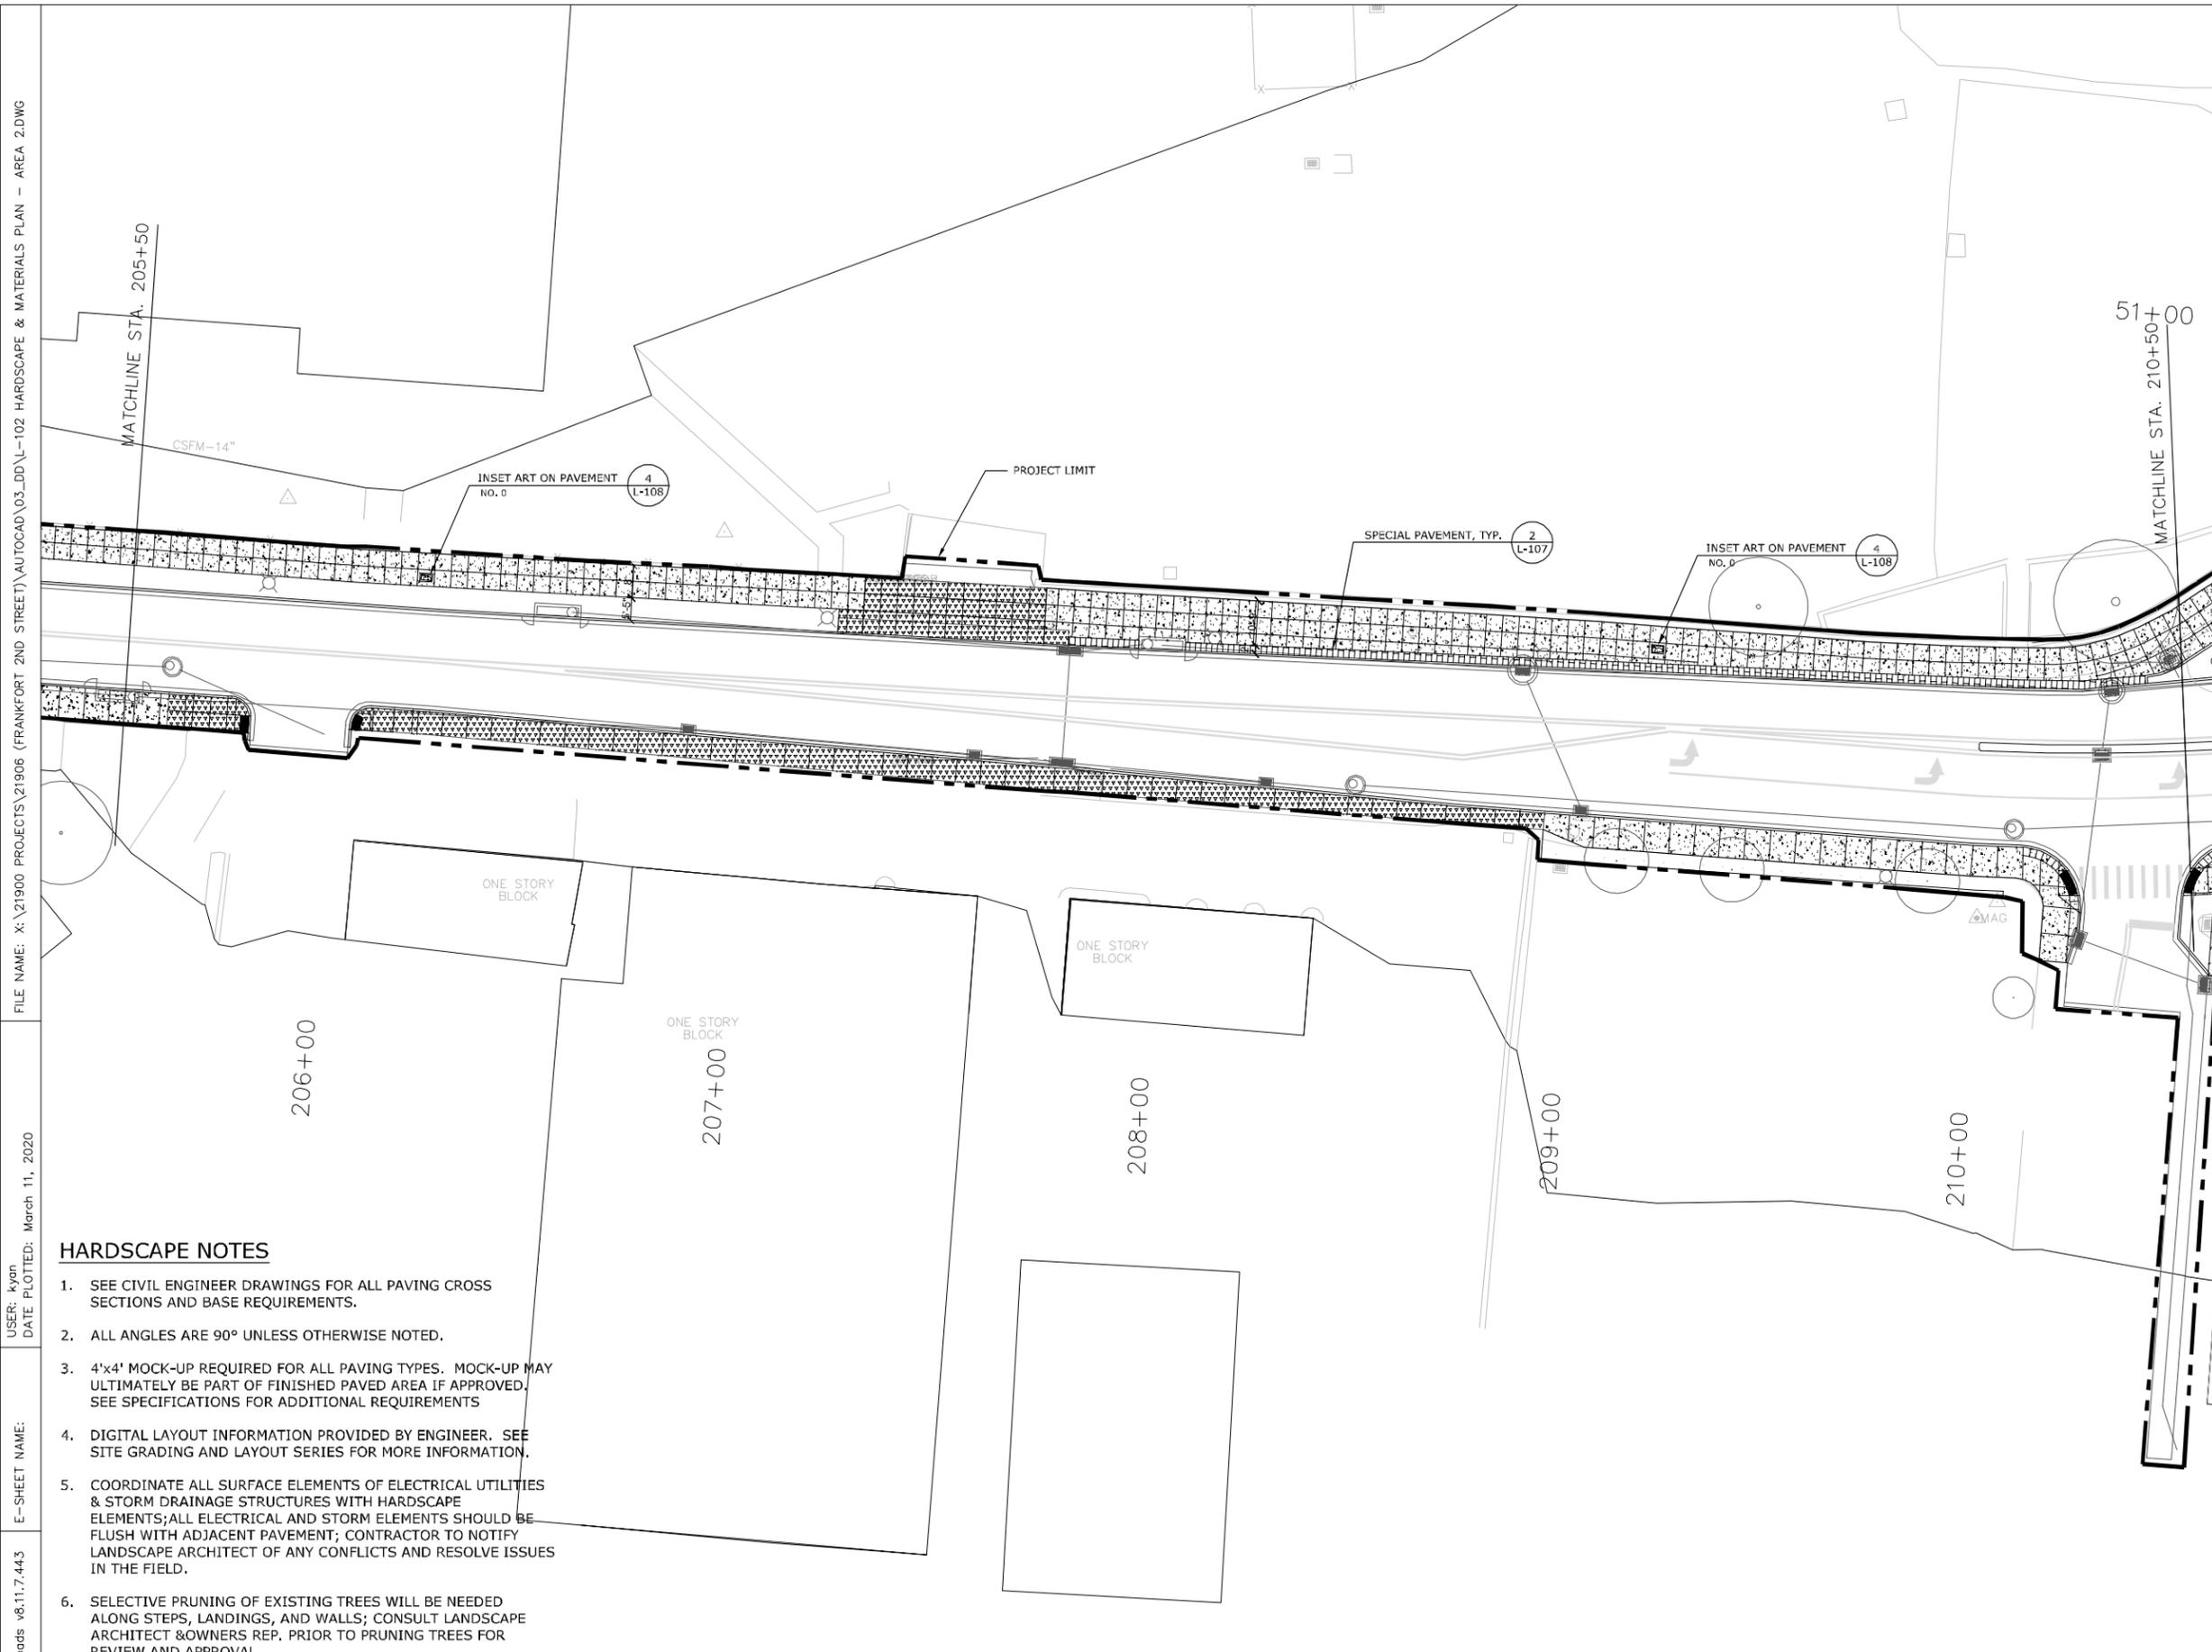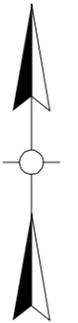

FILE NAME: X:\21900 PROJECTS\21906 (FRANKFORT 2ND STREET)\AUTOCAD\03_DD\L-102 HARDSCAPE & MATERIALS PLAN - AREA 2.DWG
 USER: kyon
 DATE PLOTTED: March 11, 2020
 E-SHEET NAME:
 Power InRoads v8.11.7.443

HARDSCAPE NOTES

1. SEE CIVIL ENGINEER DRAWINGS FOR ALL PAVING CROSS SECTIONS AND BASE REQUIREMENTS.
2. ALL ANGLES ARE 90° UNLESS OTHERWISE NOTED.
3. 4'x4' MOCK-UP REQUIRED FOR ALL PAVING TYPES. MOCK-UP MAY ULTIMATELY BE PART OF FINISHED PAVED AREA IF APPROVED. SEE SPECIFICATIONS FOR ADDITIONAL REQUIREMENTS
4. DIGITAL LAYOUT INFORMATION PROVIDED BY ENGINEER. SEE SITE GRADING AND LAYOUT SERIES FOR MORE INFORMATION.
5. COORDINATE ALL SURFACE ELEMENTS OF ELECTRICAL UTILITIES & STORM DRAINAGE STRUCTURES WITH HARDSCAPE ELEMENTS; ALL ELECTRICAL AND STORM ELEMENTS SHOULD BE FLUSH WITH ADJACENT PAVEMENT; CONTRACTOR TO NOTIFY LANDSCAPE ARCHITECT OF ANY CONFLICTS AND RESOLVE ISSUES IN THE FIELD.
6. SELECTIVE PRUNING OF EXISTING TREES WILL BE NEEDED ALONG STEPS, LANDINGS, AND WALLS; CONSULT LANDSCAPE ARCHITECT & OWNERS REP. PRIOR TO PRUNING TREES FOR REVIEW AND APPROVAL
7. THESE HARDSCAPE NOTES APPLY TO ALL "L-1XX" SERIES DRAWINGS

HARDSCAPE MATERIAL SCHEDULE	
KEY	ITEM
	CONCRETE TYPE 1, SIDEWALK & MULTI-USE PATH
	CONCRETE TYPE 2, DRIVEWAY, CURB CUT
	POROUS PAVEMENT
	PAVERS; CLAY; 2.25" THICK
	ADA TRUNCATED DOME PLATE
	MULTI-USE PATH STENCIL
	INSET ART ON PAVEMENT

* SEE SPECIFICATIONS FOR ADDITIONAL INFORMATION AND REQUIREMENTS





SCALE: 1"=20'
 SECOND STREET (US 60)
 STA. 205+50 TO STA. 210+50
 HARDSCAPE & MATERIALS PLAN - AREA 2

Power InRoads v8.11.7.443 E-SHEET NAME: USER: kyon DATE PLOTTED: March 11, 2020 FILE NAME: X:\21900 PROJECTS\21906 (FRANKFORT 2ND STREET)\AUTOCAD\03.DWG\03.L-103 HARDSCAPE & MATERIALS PLAN - AREA 3.DWG

COUNTY OF	ITEM NO.	SHEET NO.
FRANKLIN	5-565	L-103

HARDSCAPE NOTES

1. SEE CIVIL ENGINEER DRAWINGS FOR ALL PAVING CROSS SECTIONS AND BASE REQUIREMENTS.
2. ALL ANGLES ARE 90° UNLESS OTHERWISE NOTED.
3. 4'x4' MOCK-UP REQUIRED FOR ALL PAVING TYPES. MOCK-UP MAY ULTIMATELY BE PART OF FINISHED PAVED AREA IF APPROVED. SEE SPECIFICATIONS FOR ADDITIONAL REQUIREMENTS
4. DIGITAL LAYOUT INFORMATION PROVIDED BY ENGINEER. SEE SITE GRADING AND LAYOUT SERIES FOR MORE INFORMATION.
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7. THESE HARDSCAPE NOTES APPLY TO ALL "L-1XX" SERIES DRAWINGS

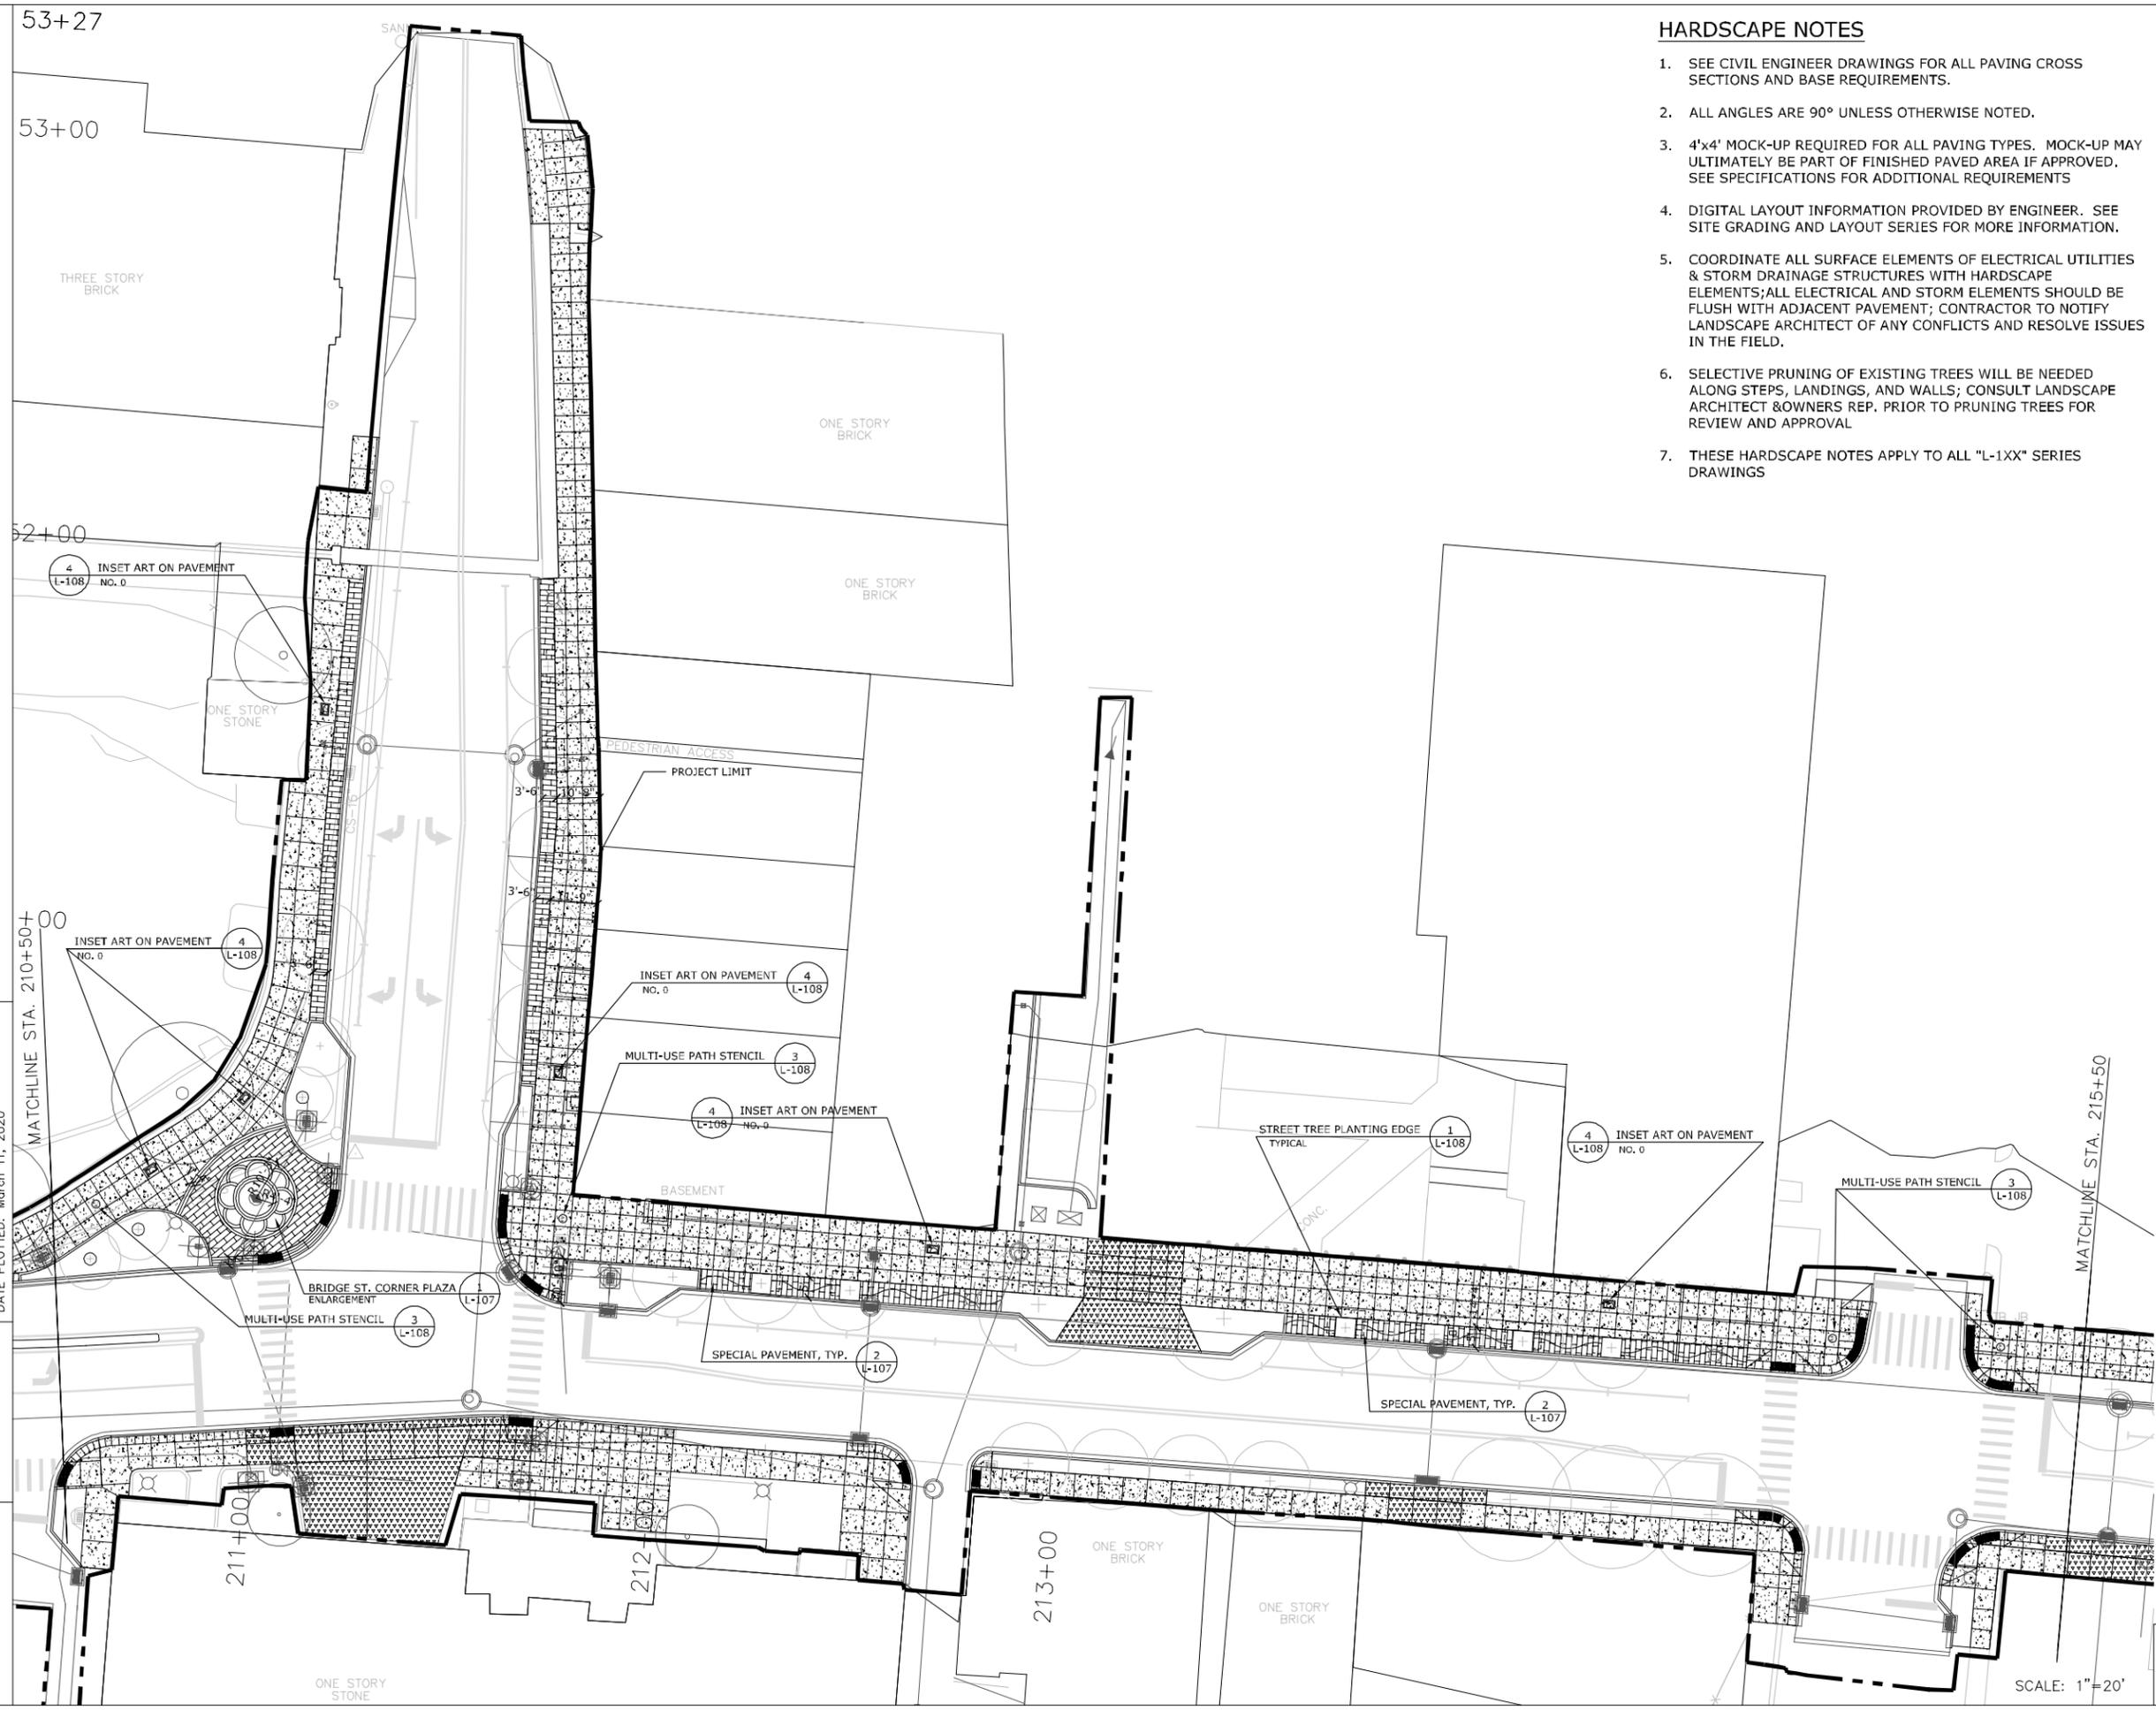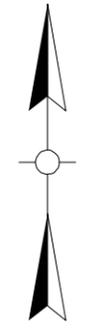

HARDSCAPE MATERIAL SCHEDULE	
KEY	ITEM
	CONCRETE TYPE 1, SIDEWALK & MULTI-USE PATH
	CONCRETE TYPE 2, DRIVEWAY, CURB CUT
	POROUS PAVEMENT
	PAVERS; CLAY; 2.25" THICK
	ADA TRUNCATED DOME PLATE
	MULTI-USE PATH STENCIL
	INSET ART ON PAVEMENT

* SEE SPECIFICATIONS FOR ADDITIONAL INFORMATION AND REQUIREMENTS




SECOND STREET (US 60) STA. 210+50 TO STA. 215+50 & BRIDGE STREET HARDSCAPE & MATERIALS PLAN - AREA 3

SCALE: 1"=20'


COUNTY OF	ITEM NO.	SHEET NO.
FRANKLIN	5-565	L-104

HARDSCAPE NOTES

1. SEE CIVIL ENGINEER DRAWINGS FOR ALL PAVING CROSS SECTIONS AND BASE REQUIREMENTS.
2. ALL ANGLES ARE 90° UNLESS OTHERWISE NOTED.
3. 4'x4' MOCK-UP REQUIRED FOR ALL PAVING TYPES. MOCK-UP MAY ULTIMATELY BE PART OF FINISHED PAVED AREA IF APPROVED. SEE SPECIFICATIONS FOR ADDITIONAL REQUIREMENTS
4. DIGITAL LAYOUT INFORMATION PROVIDED BY ENGINEER. SEE SITE GRADING AND LAYOUT SERIES FOR MORE INFORMATION.
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7. THESE HARDSCAPE NOTES APPLY TO ALL "L-1XX" SERIES DRAWINGS

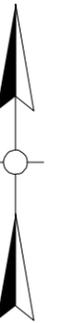


FILE NAME: X:\21900 PROJECTS\21906 (FRANKFORT 2ND STREET)\AUTOCAD\03_DD\L-104 HARDSCAPE & MATERIALS PLAN - AREA 4.DWG
 USER: kyon
 DATE PLOTTED: March 11, 2020
 E-SHEET NAME:
 Power InRoads v8.11.7.443

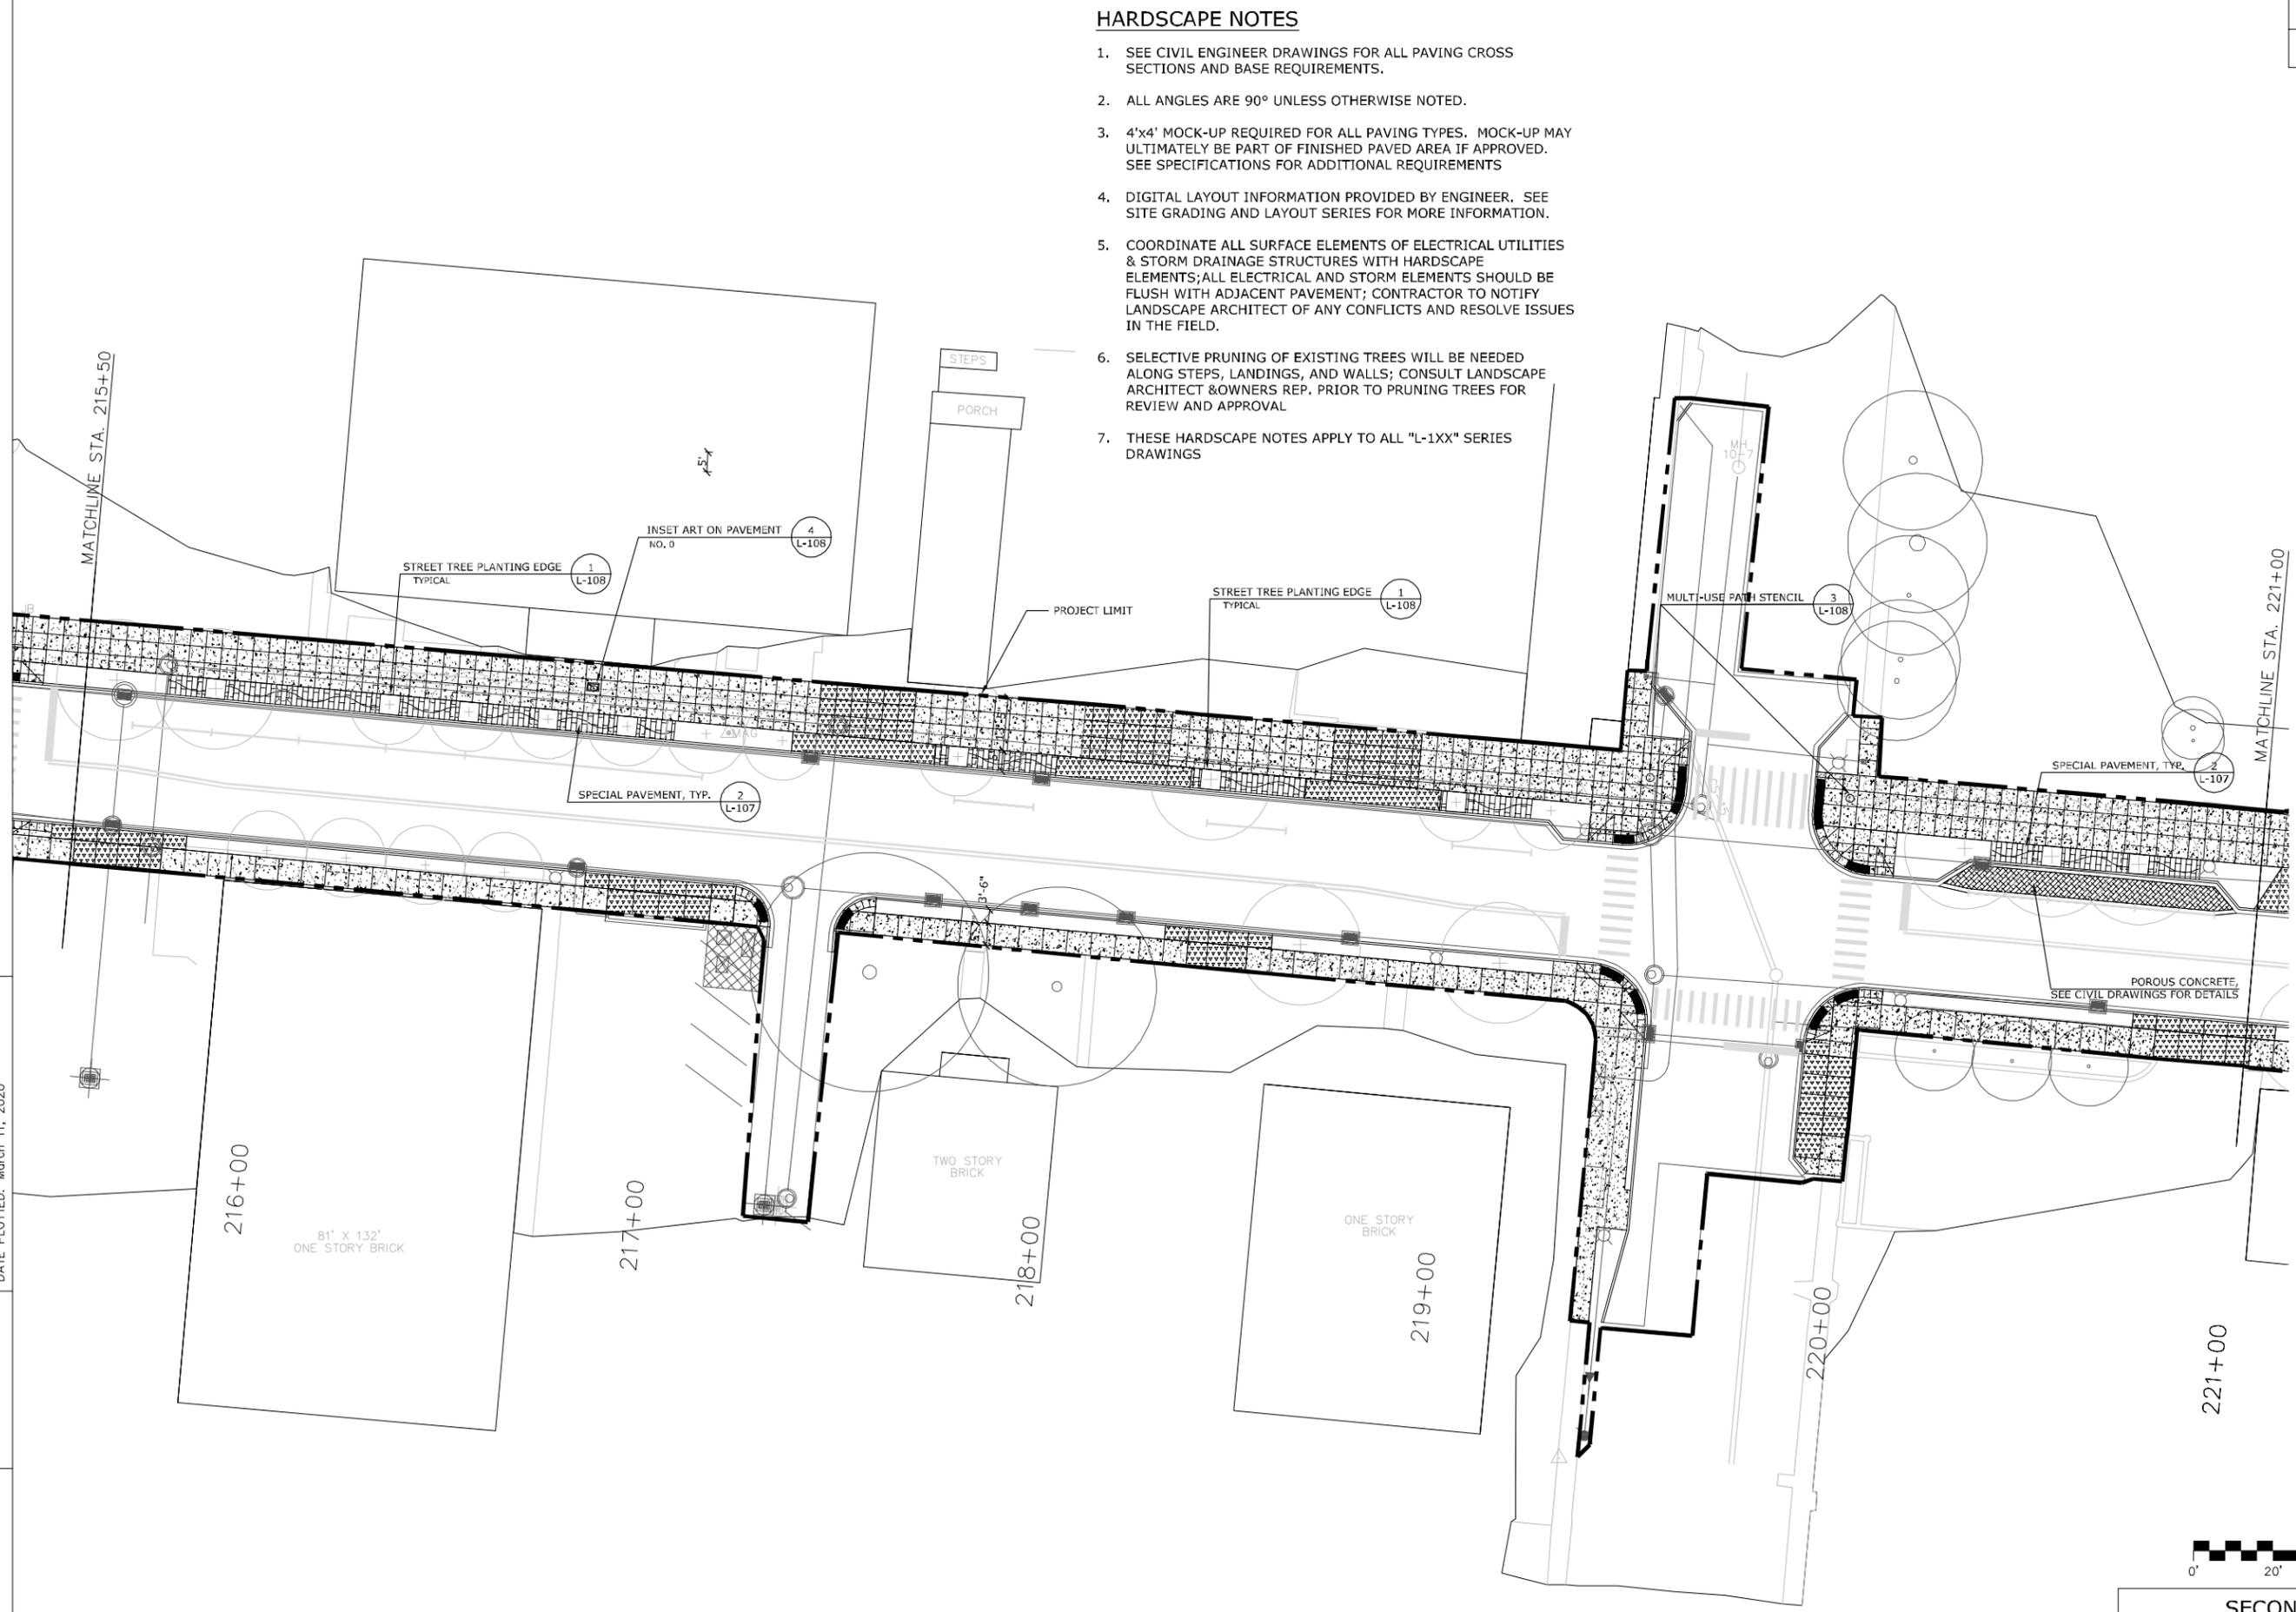

HARDSCAPE MATERIAL SCHEDULE	
KEY	ITEM
	CONCRETE TYPE 1, SIDEWALK & MULTI-USE PATH
	CONCRETE TYPE 2, DRIVEWAY, CURB CUT
	POROUS PAVEMENT
	PAVERS; CLAY; 2.25" THICK
	ADA TRUNCATED DOME PLATE
	MULTI-USE PATH STENCIL
	INSET ART ON PAVEMENT

* SEE SPECIFICATIONS FOR ADDITIONAL INFORMATION AND REQUIREMENTS

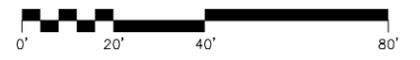



SCALE: 1"=20'
 SECOND STREET (US 60)
 STA. 215+50 TO STA. 221+00
 HARDSCAPE & MATERIALS PLAN - AREA 4

FILE NAME: X:\21900 PROJECTS\21906 (FRANKFORT 2ND STREET)\AUTOCAD\03.DWG L-105 HARDSCAPE & MATERIALS PLAN - AREA 5.DWG
 USER: kyon
 DATE PLOTTED: March 11, 2020
 E-SHEET NAME: Power InRoads v8.11.7.443

HARDSCAPE NOTES

1. SEE CIVIL ENGINEER DRAWINGS FOR ALL PAVING CROSS SECTIONS AND BASE REQUIREMENTS.
2. ALL ANGLES ARE 90° UNLESS OTHERWISE NOTED.
3. 4'x4' MOCK-UP REQUIRED FOR ALL PAVING TYPES. MOCK-UP MAY ULTIMATELY BE PART OF FINISHED PAVED AREA IF APPROVED. SEE SPECIFICATIONS FOR ADDITIONAL REQUIREMENTS
4. DIGITAL LAYOUT INFORMATION PROVIDED BY ENGINEER. SEE SITE GRADING AND LAYOUT SERIES FOR MORE INFORMATION.
5. COORDINATE ALL SURFACE ELEMENTS OF ELECTRICAL UTILITIES & STORM DRAINAGE STRUCTURES WITH HARDSCAPE ELEMENTS; ALL ELECTRICAL AND STORM ELEMENTS SHOULD BE FLUSH WITH ADJACENT PAVEMENT; CONTRACTOR TO NOTIFY LANDSCAPE ARCHITECT OF ANY CONFLICTS AND RESOLVE ISSUES IN THE FIELD.
6. SELECTIVE PRUNING OF EXISTING TREES WILL BE NEEDED ALONG STEPS, LANDINGS, AND WALLS; CONSULT LANDSCAPE ARCHITECT & OWNERS REP. PRIOR TO PRUNING TREES FOR REVIEW AND APPROVAL
7. THESE HARDSCAPE NOTES APPLY TO ALL "L-1XX" SERIES DRAWINGS

COUNTY OF	ITEM NO.	SHEET NO.
FRANKLIN	5-565	L-105

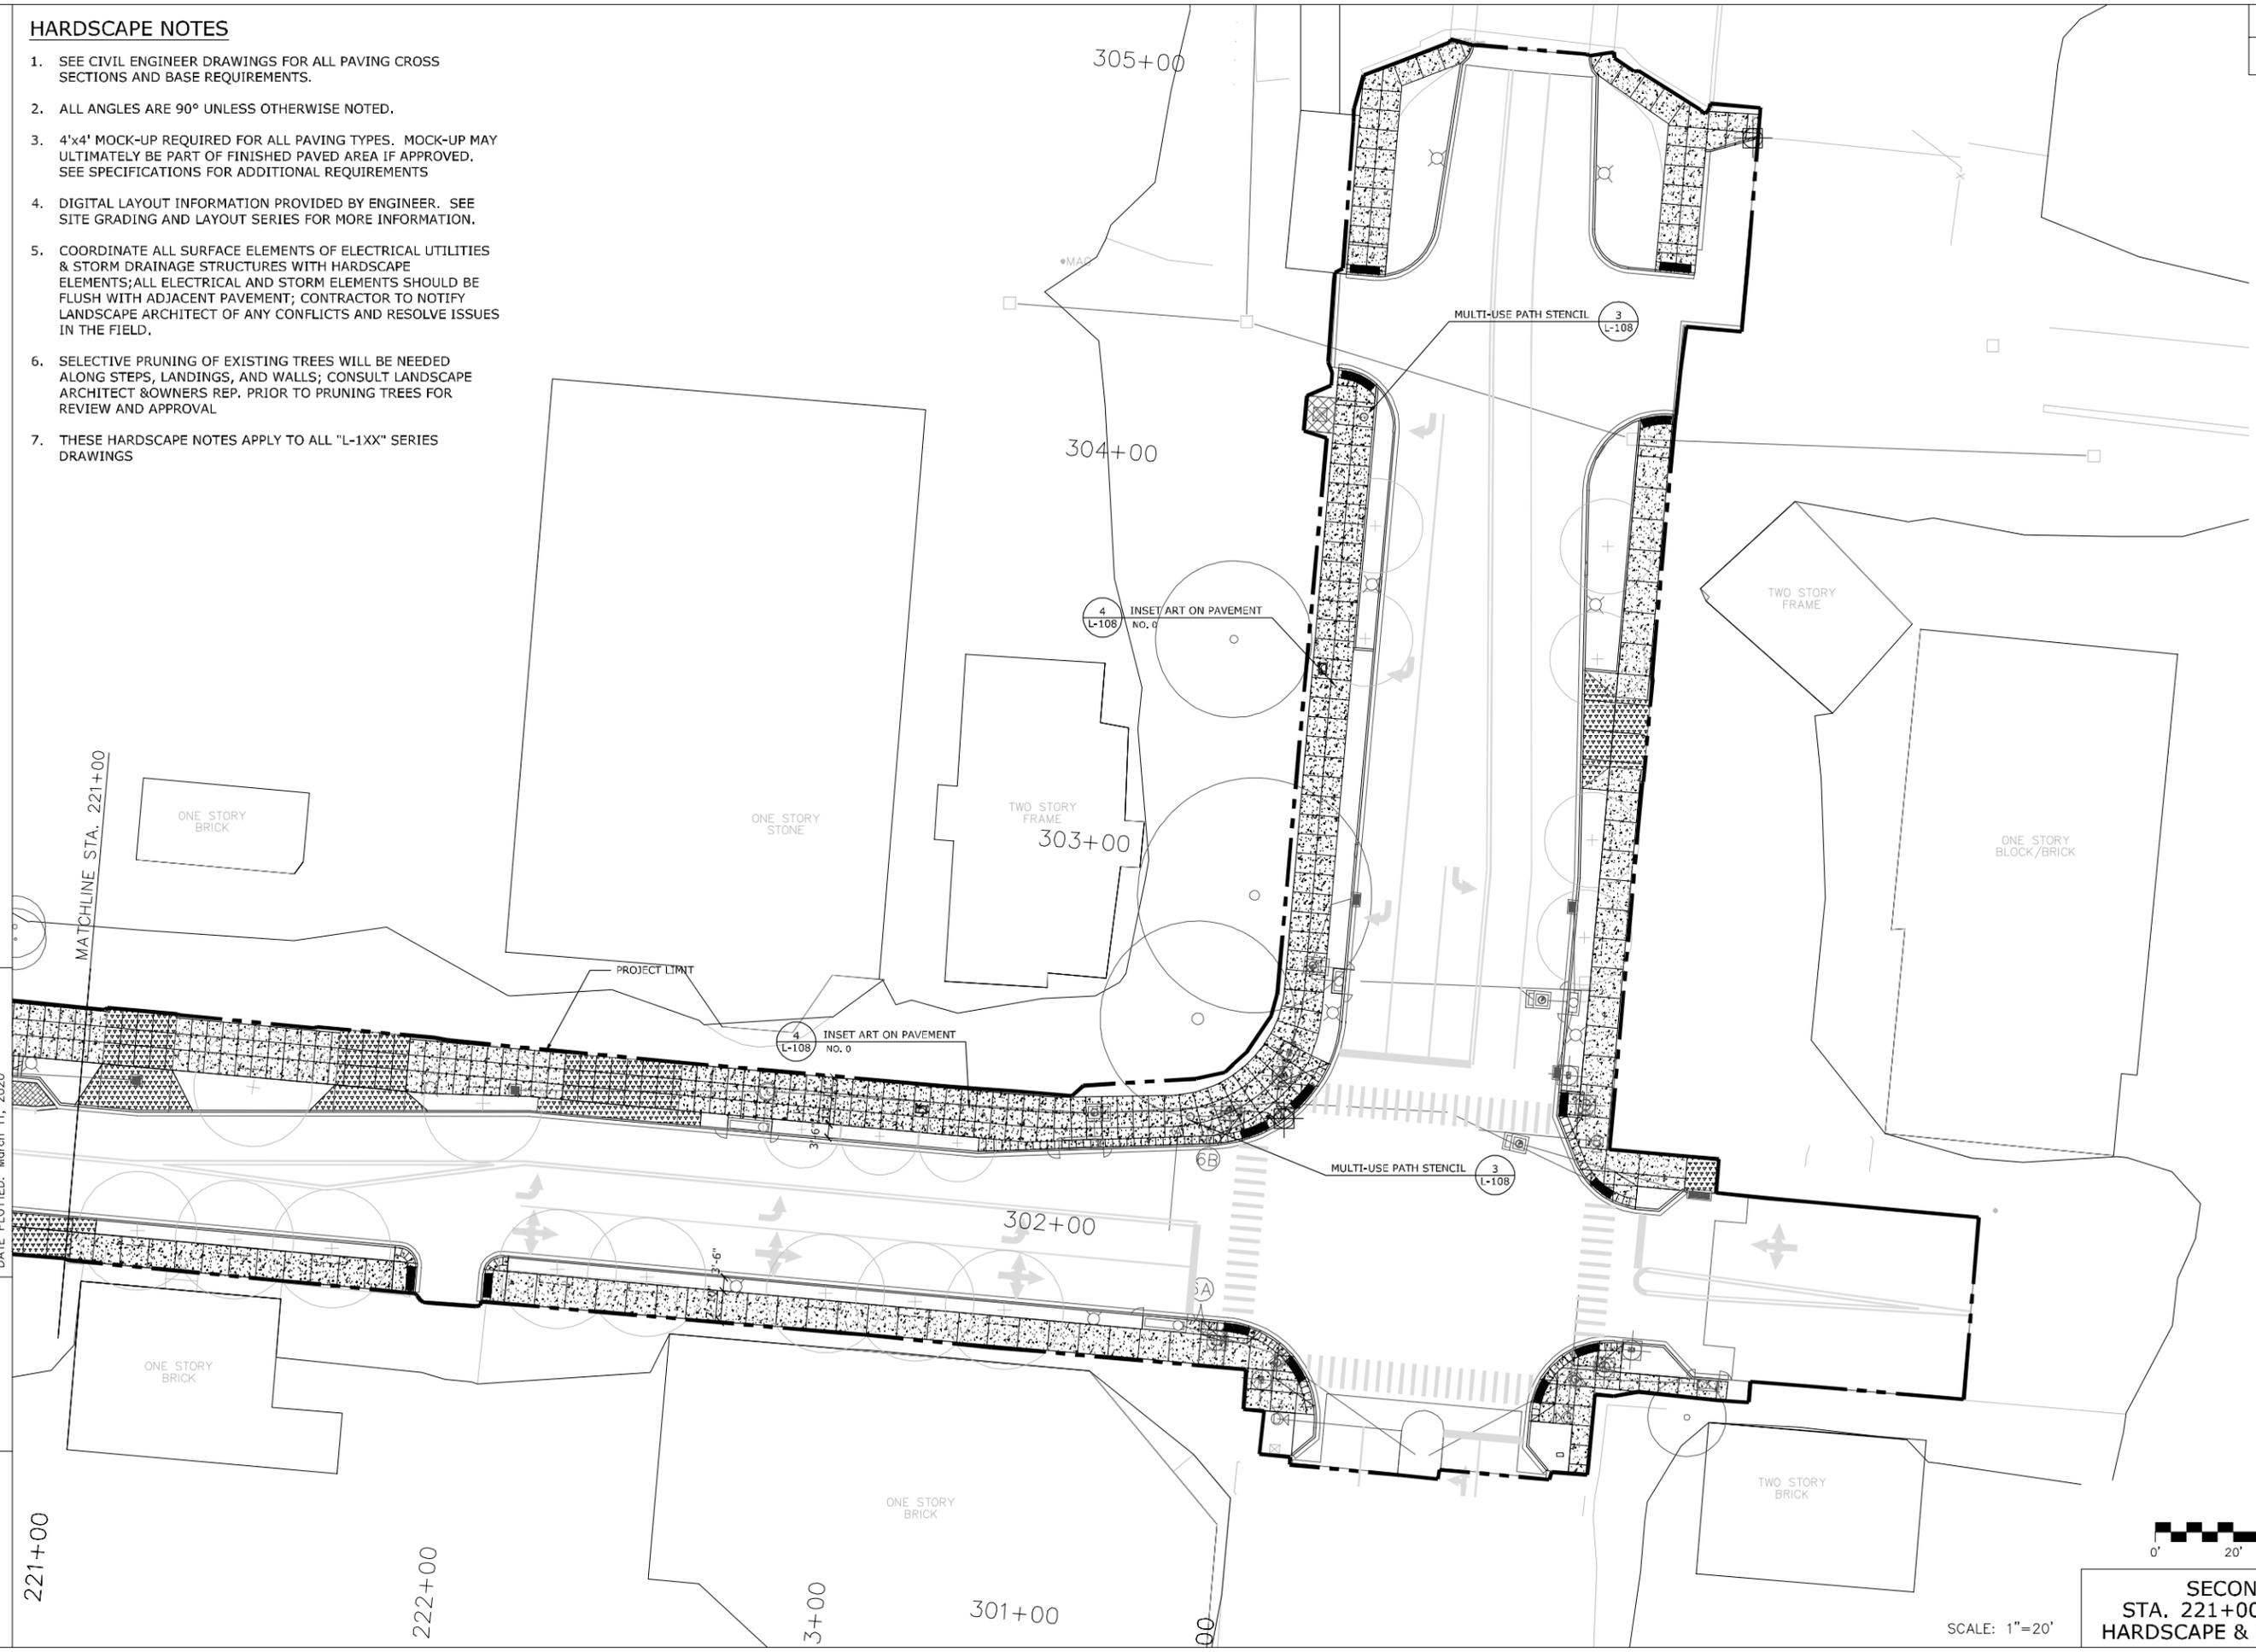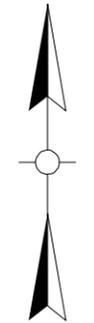

HARDSCAPE MATERIAL SCHEDULE	
KEY	ITEM
	CONCRETE TYPE 1, SIDEWALK & MULTI-USE PATH
	CONCRETE TYPE 2, DRIVEWAY, CURB CUT
	POROUS PAVEMENT
	PAVERS; CLAY; 2.25" THICK
	ADA TRUNCATED DOME PLATE
	MULTI-USE PATH STENCIL
	INSET ART ON PAVEMENT

* SEE SPECIFICATIONS FOR ADDITIONAL INFORMATION AND REQUIREMENTS





SCALE: 1"=20'
**SECOND STREET (US 60)
 STA. 221+00 TO END & CAPITAL AVE
 HARDSCAPE & MATERIALS PLAN - AREA 5**

FILE NAME: X:\21900 PROJECTS\21906 (FRANKFORT 2ND STREET)\AUTOCAD\03_DD\L-106 HARDSCAPE & MATERIALS PLAN - AREA 6 & 7.DWG
 USER: kyan
 DATE PLOTTED: March 11, 2020
 E-SHEET NAME:
 Power InRoads v8.11.7.443

COUNTY OF	ITEM NO.	SHEET NO.
FRANKLIN	5-565	L-106

HARDSCAPE NOTES


- SEE CIVIL ENGINEER DRAWINGS FOR ALL PAVING CROSS SECTIONS AND BASE REQUIREMENTS.
- ALL ANGLES ARE 90° UNLESS OTHERWISE NOTED.
- 4'x4' MOCK-UP REQUIRED FOR ALL PAVING TYPES. MOCK-UP MAY ULTIMATELY BE PART OF FINISHED PAVED AREA IF APPROVED. SEE SPECIFICATIONS FOR ADDITIONAL REQUIREMENTS
- DIGITAL LAYOUT INFORMATION PROVIDED BY ENGINEER. SEE SITE GRADING AND LAYOUT SERIES FOR MORE INFORMATION.
- COORDINATE ALL SURFACE ELEMENTS OF ELECTRICAL UTILITIES & STORM DRAINAGE STRUCTURES WITH HARDSCAPE ELEMENTS; ALL ELECTRICAL AND STORM ELEMENTS SHOULD BE FLUSH WITH ADJACENT PAVEMENT; CONTRACTOR TO NOTIFY LANDSCAPE ARCHITECT OF ANY CONFLICTS AND RESOLVE ISSUES IN THE FIELD.
- SELECTIVE PRUNING OF EXISTING TREES WILL BE NEEDED ALONG STEPS, LANDINGS, AND WALLS; CONSULT LANDSCAPE ARCHITECT & OWNERS REP. PRIOR TO PRUNING TREES FOR REVIEW AND APPROVAL
- THESE HARDSCAPE NOTES APPLY TO ALL "L-1XX" SERIES DRAWINGS

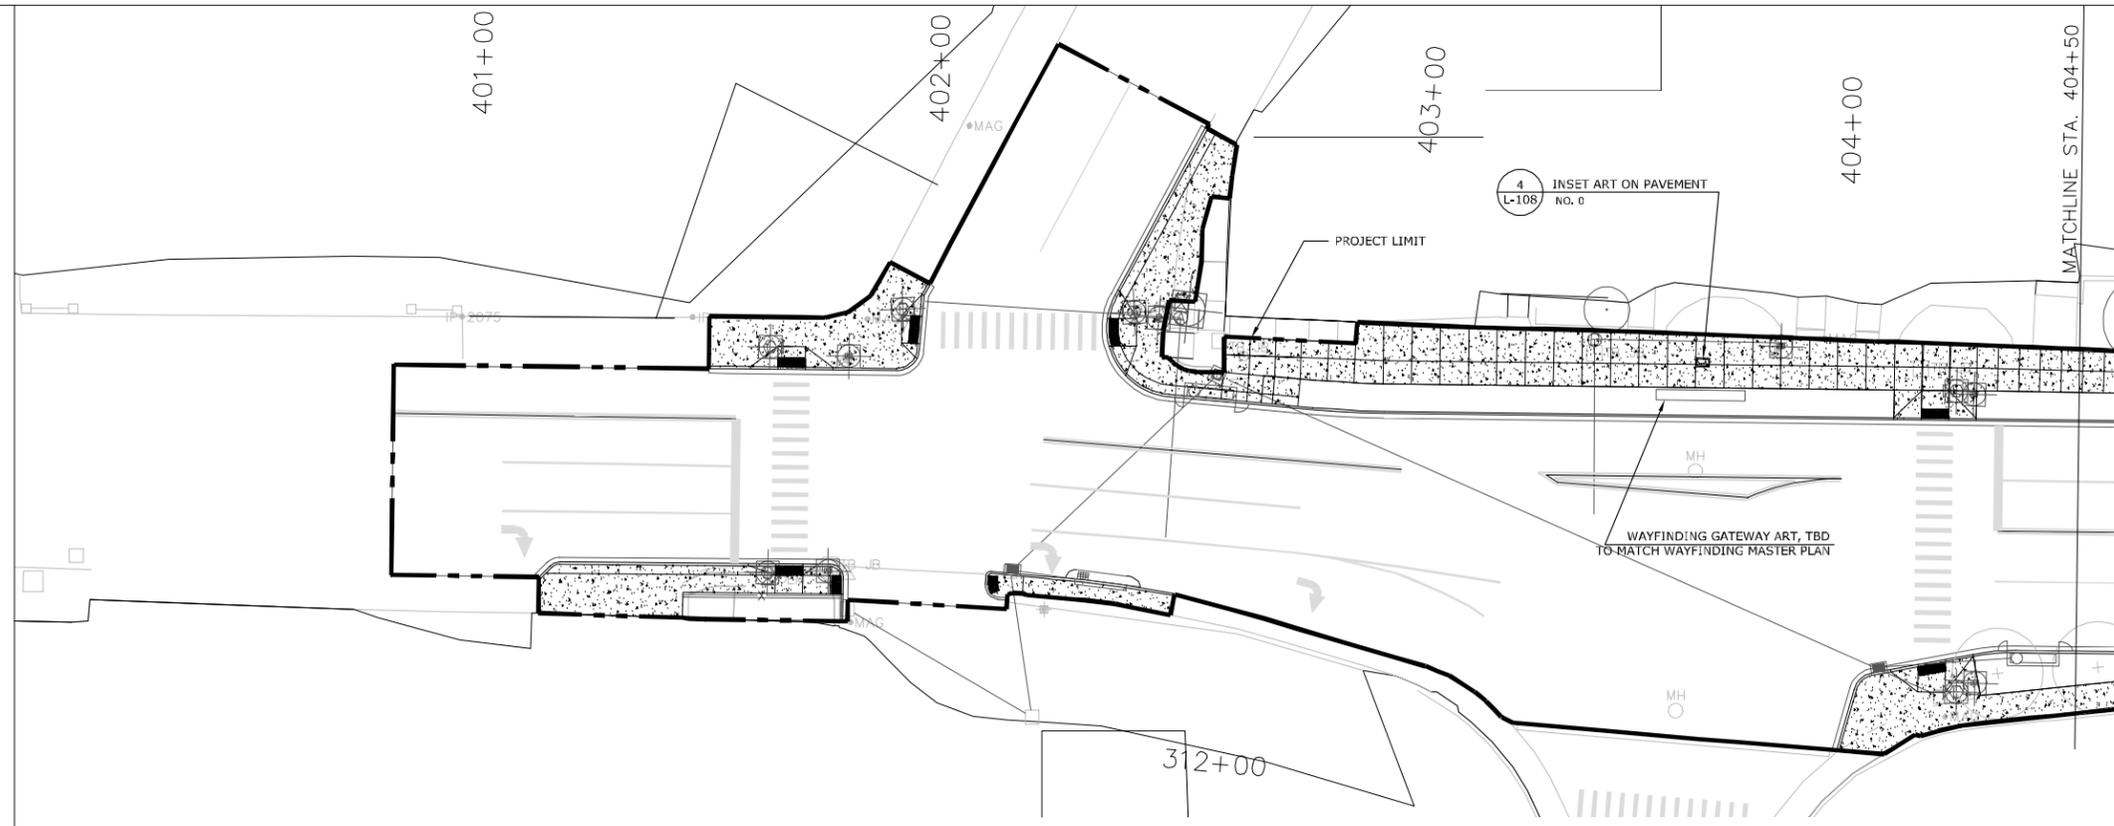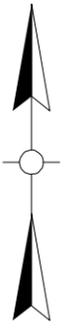

1 MAIN STREET (BEGINNING TO STA. 404+50)
SCALE: 1" = 20'

HARDSCAPE MATERIAL SCHEDULE	
KEY	ITEM
	CONCRETE TYPE 1, SIDEWALK & MULTI-USE PATH
	CONCRETE TYPE 2, DRIVEWAY, CURB CUT
	POROUS PAVEMENT
	PAVERS; CLAY; 2.25" THICK
	ADA TRUNCATED DOME PLATE
	MULTI-USE PATH STENCIL
	INSET ART ON PAVEMENT

* SEE SPECIFICATIONS FOR ADDITIONAL INFORMATION AND REQUIREMENTS

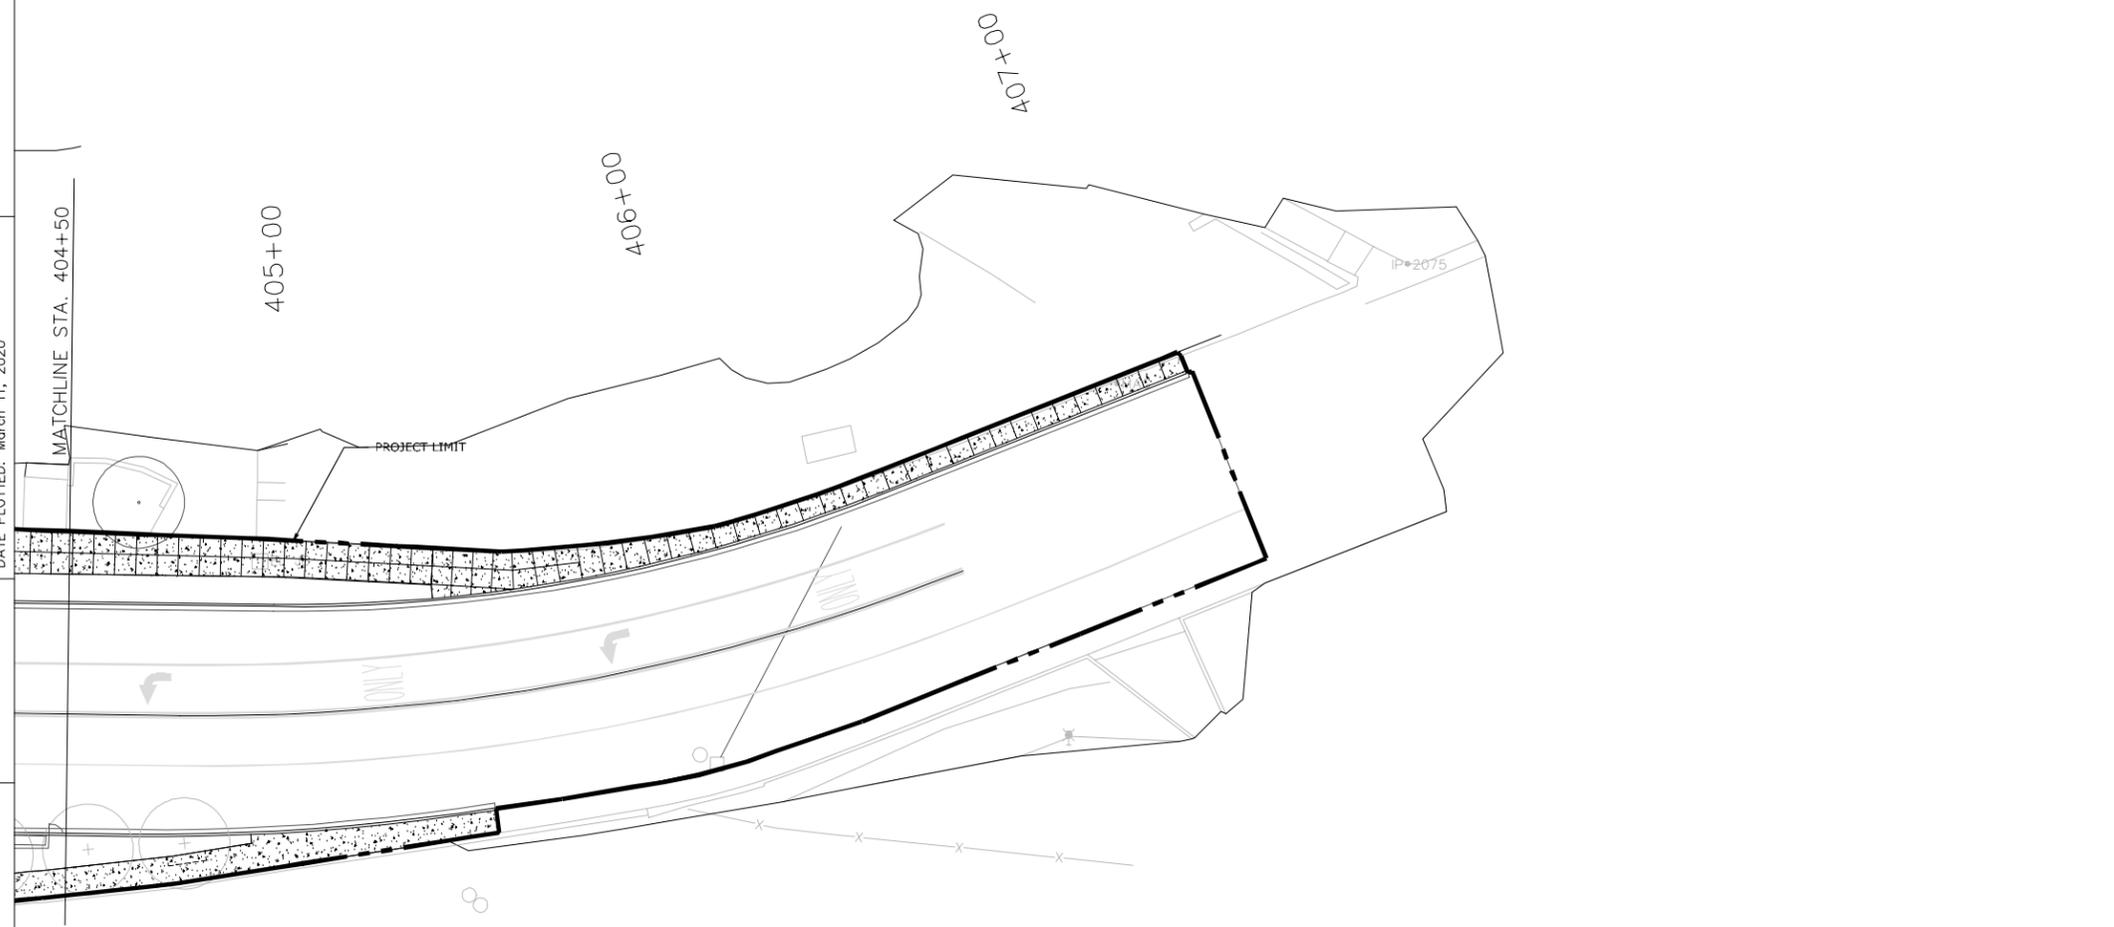

2 MAIN STREET (STA. 404+50 TO END.)
SCALE: 1" = 20'



MAIN STREET (US 60/ KY 420)
BEGINNING TO END.
HARDSCAPE & MATERIALS PLAN - AREA 6 & 7

SCALE: 1"=20'


COUNTY OF	ITEM NO.	SHEET NO.
FRANKLIN	5-565	L-107

FILE NAME: X:\21900 PROJECTS\21906 (FRANKFORT 2ND STREET)\AUTOCAD\03_DD\L-107 HARDSCAPE & MATERIALS ENLARGEMENTS.DWG


USER: Kyan
DATE PLOTTED: March 11, 2020

E-SHEET NAME:

Power InRoads v8.11.7.443

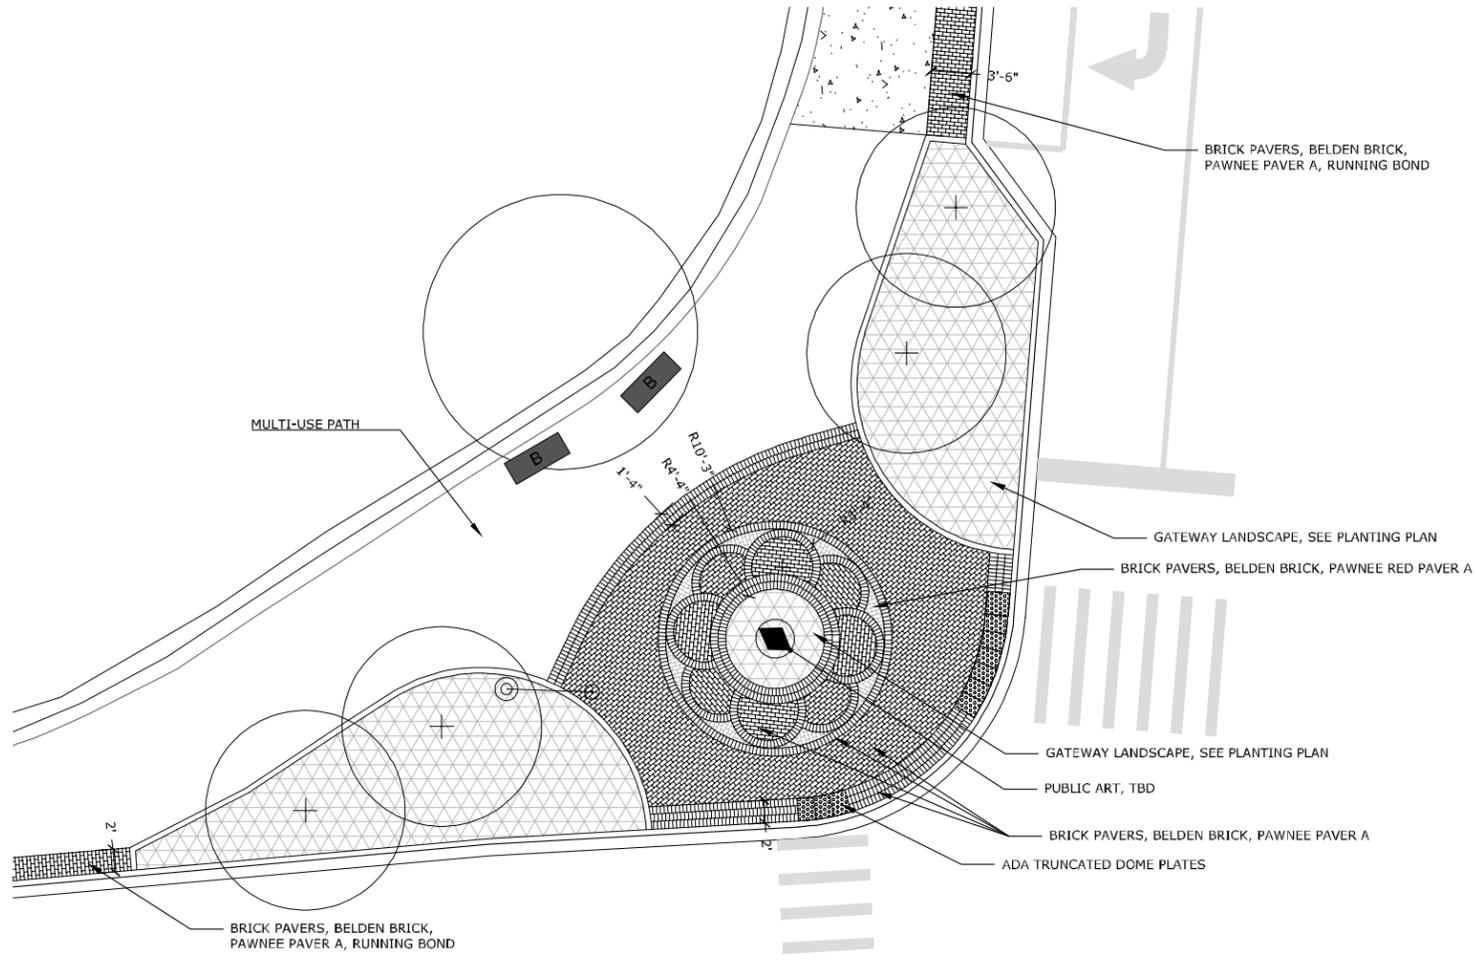


1 BRIDGE ST. CORNER PLAZA ENLARGEMENT
SCALE: 1/8" = 1'-0"

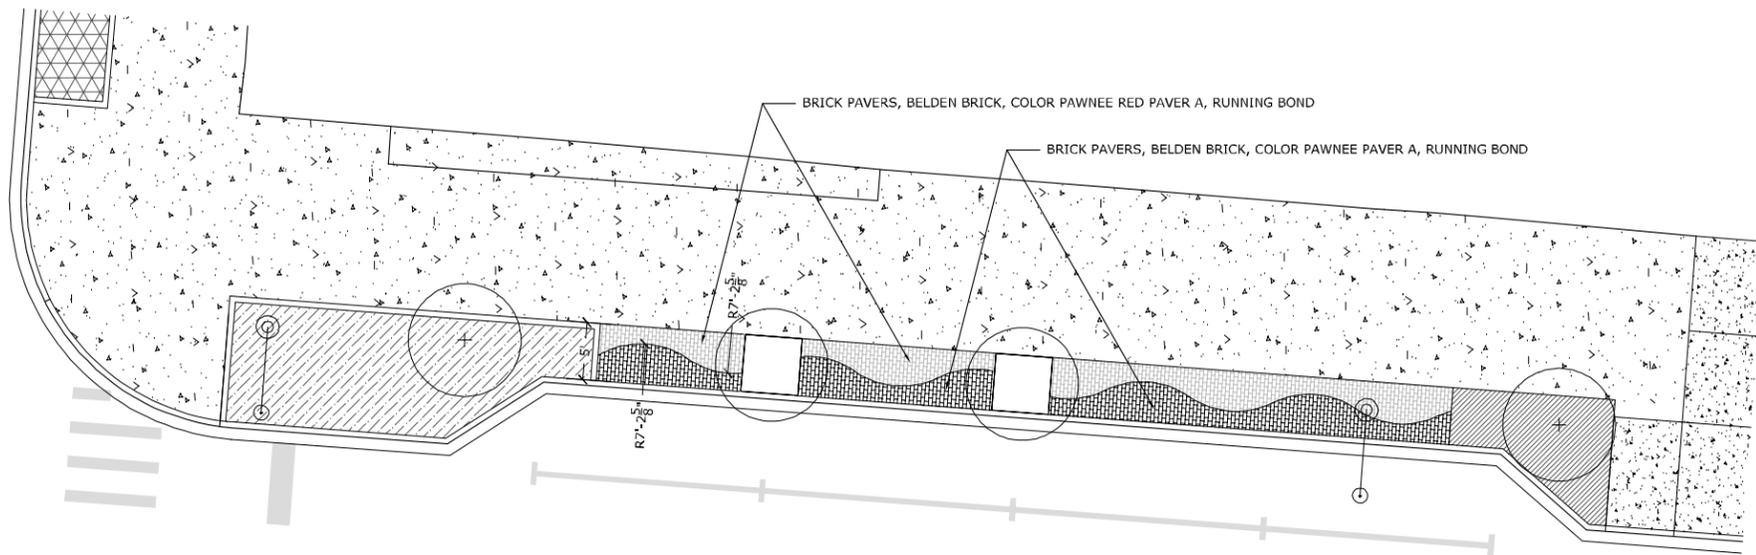


2 SPECIAL PAVING BAND - TYPICAL
SCALE: 1/8" = 1'-0"


COUNTY OF	ITEM NO.	SHEET NO.
FRANKLIN	5-565	L-108

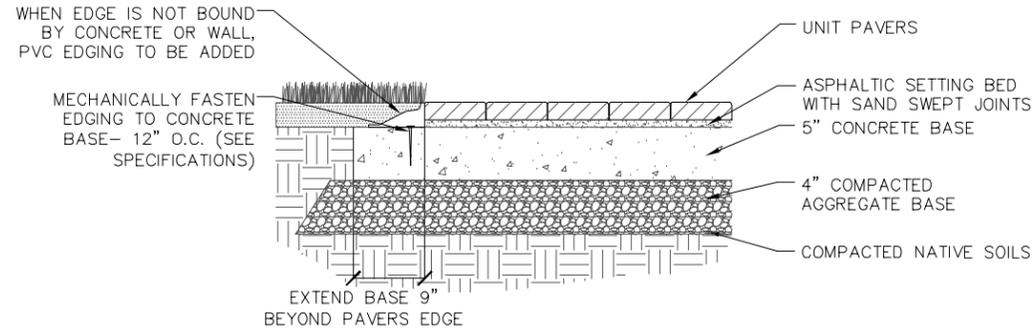

1 STREET TREE PLANTING EDGE
SCALE: 1" = 1'-0"

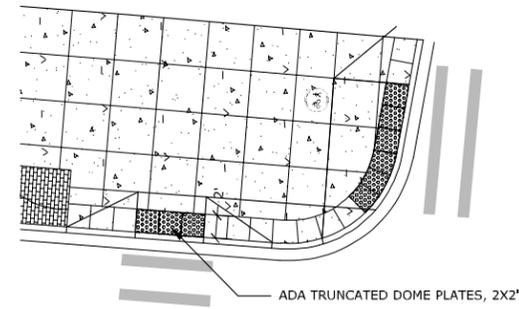

2 TYPICAL CORNER WITH TWO ADA RAMPS
SCALE: 1/8" = 1'-0"


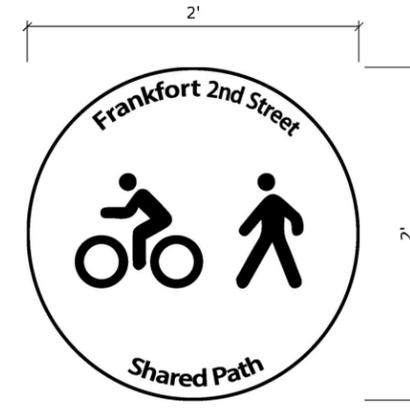


NOTE:
Position of bike and pedestrian symbols depend on facing directions.
Going east, the bike symbol would be on the right;
Going west, the bike symbol would be on the left.

3 MULTI-USE PATH STENCIL ON PAVEMENT
SCALE: N.T.S.

Potential Frankfort 2nd Street Historical Interpretive Panels

- 1915 Winnie A. Scott Memorial Hospital established to serve the African American community
- 1917 Farmers Tobacco Warehouse
- 1839 B. C. Milam & Son made high quality fishing reels that were valued nationwide and beyond
- Mid-20th Century 2nd Street was known as "Gasoline Alley" due to all of the car dealerships and gasoline stations
- 1869 Benjamin Meek, a silversmith and one of the founders of the Meek and Milam fishing reel, built this distinctive home in South Frankfort
- 1890s Covered bridge at Bridge Street before the "Singing Bridge" was constructed
- 1950's George W. Gayle & Son factory was the largest producer of military dog tags in the country for the Korean War
- 1929 Frankfort Lumber & Manufacturing located near Capital Avenue was one of the major employers in South Frankfort
- 1920s to 1950s Pete's Corner was a popular place to eat, drink, and socialize
- 1921 The Ziegler House, designed by famed architect Frank Lloyd Wright, was built for Reverend Jesse Ziegler
- 1905 to 1909 A rail line ran down the middle of 2nd Street to help transport building materials for the construction of the state capitol building
- 1818 John H. Hanna built one of the first houses in South Frankfort

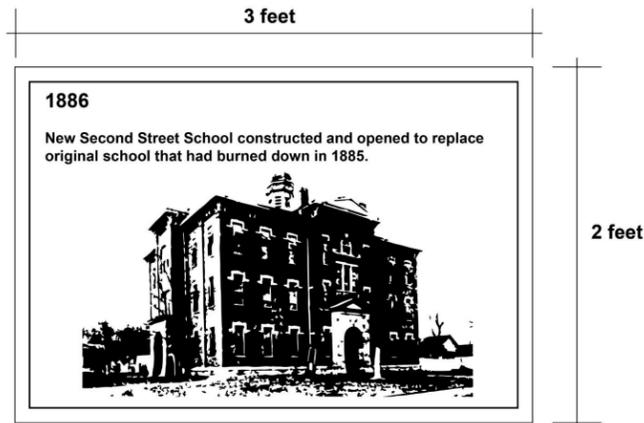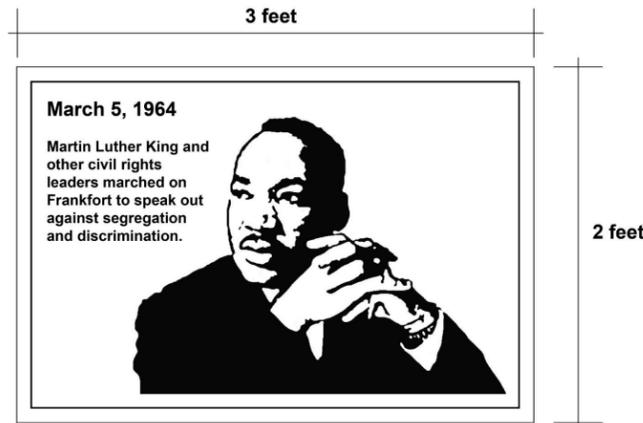

4 INSET ART ON PAVEMENT
SCALE: N.T.S.

FILE NAME: X:\21900 PROJECTS\21906 (FRANKFORT 2ND STREET)\AUTOCAD\03_DD\L-108 SITE DETAILS.DWG



USER: kyan
DATE PLOTTED: March 11, 2020

E-SHEET NAME:

Power InRoads v8.11.7.443


SITE FURNISHINGS SCHEDULE

KEY	ITEM	MANUFACTURER (BASIS OF DESIGN OR APPROVED EQUAL)	MODEL	COLOR	SIZE	COMMENTS	QUANTITY
↑↑↑	BIKE RACK	ANOVA Contact: JULIE NASH (OH, KY) 614-581-6399 julie.n@anovafurnishings.com	ALLURE Item N#: AL19BR2	TEXTURED PEWTER	33"H x 5"W x 13"L	SEE DETAIL 1/L-207	6
■	BENCH	ANOVA Contact: JULIE NASH (OH, KY) 614-581-6399 julie.n@anovafurnishings.com	AIRI LEAF 6' CONTOUR BENCH Item N#: AE2680LF	FRAME: TEXTURED PEWTER; SEAT: BLUE	35"H x 23"W x 75"L	SEE DETAIL 2/L-207	16
●	TRASH RECEPTACLE	ANOVA Contact: JULIE NASH (OH, KY) 614-581-6399 julie.n@anovafurnishings.com	Airi Leaf 45-Gal. Trash Receptacle w/Side Door, Curve Top Item N#: AE2645CBT-LF	PANEL/LID: BLUE; FRAME: TEXTURED PEWTER; LABEL 1: TRASH (WHITE LETTERING)	50"H x 26"W x 22"D	SEE DETAIL 3/L-207	9
●	PLANTER POT	Landscape Forms Kendra Brown Mobile: 614-558-2800 kendrab@landscapeforms.com	Model: Lakeside Planter (Leaf Pattern)	TBD	36" D x 23" H	SEE DETAIL 4/L-207	4

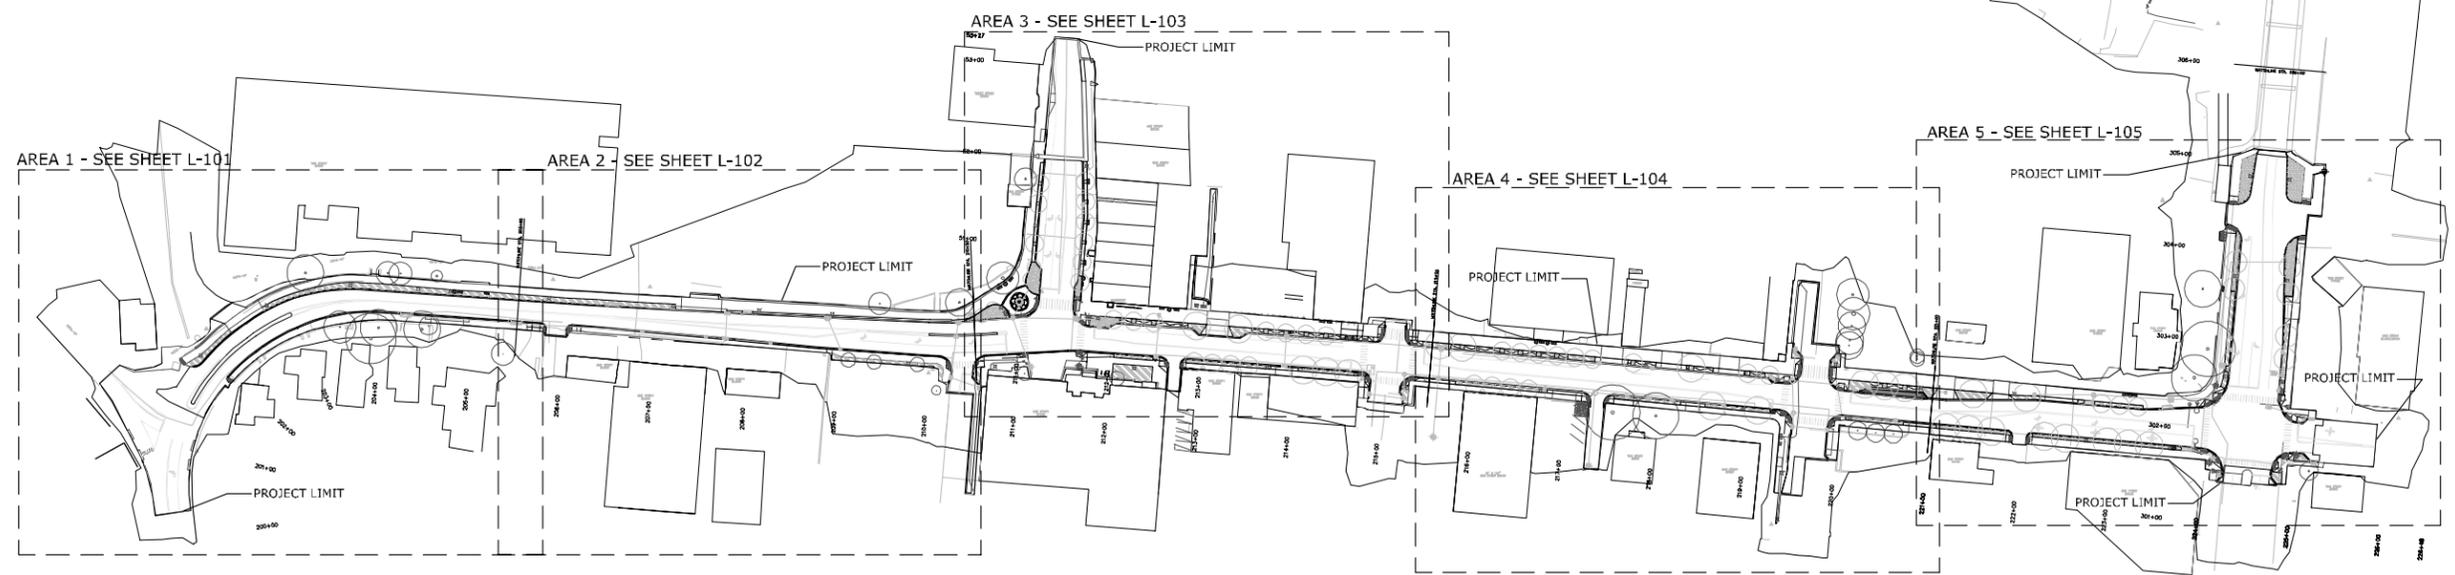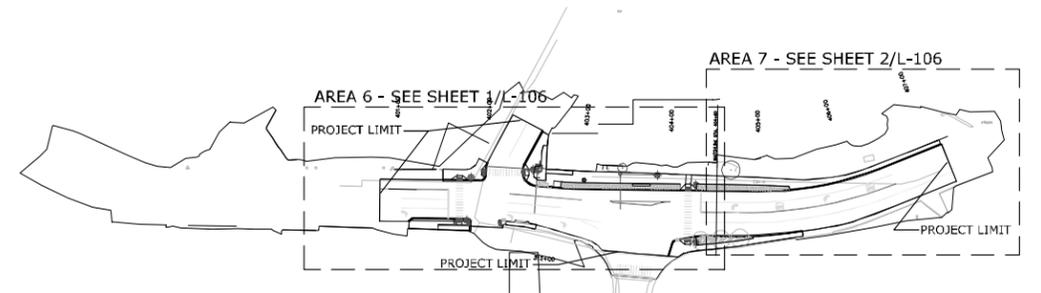

FURNISHINGS NOTES

1. INSTALLATION OF ALL FURNISHINGS PER MANUFACTURER'S RECOMMENDATIONS.
2. ALL METAL FINISHES TO BE AS NOTED IN THE FURNISHINGS SCHEDULE. SUBMIT SAMPLES FOR REVIEW BY LANDSCAPE ARCHITECT PRIOR TO ORDERING.
3. FIELD LOCATE AND STAKE ALL FURNISHINGS AND REVIEW LOCATION WITH LANDSCAPE ARCHITECT PRIOR TO INSTALLATION.
4. SUBMIT SHOP DRAWINGS AND MANUFACTURER'S PRODUCT DATA FOR ALL FURNISHINGS FOR REVIEW BY LANDSCAPE ARCHITECT.
5. LIGHT LOCATIONS FOR REFERENCE ONLY. SEE LIGHTING PLANS FOR LOCATION AND PRODUCT INFORMATION AND DETAILS.
6. THESE NOTES APPLY TO ALL SHEETS IN THE L-200 SERIES

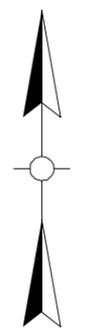

SCALE: 1"=100'

FRANKFORT SECOND STREET
OVERALL PLAN
FURNISHING PLAN OVERVIEW

FILE NAME: X:\21900 PROJECTS\21906 (FRANKFORT 2ND STREET)\AUTOCAD\03_DD\L-200 FURNISHING PLAN OVERVIEW.DWG

USER: kyon
DATE PLOTTED: March 11, 2020

E-SHEET NAME:

Power InRoads v8.11.7.443

COUNTY OF	ITEM NO.	SHEET NO.
FRANKLIN	5-565	L-201

FURNISHINGS NOTES



1. INSTALLATION OF ALL FURNISHINGS PER MANUFACTURER'S RECOMMENDATIONS.
2. ALL METAL FINISHES TO BE AS NOTED IN THE FURNISHINGS SCHEDULE. SUBMIT SAMPLES FOR REVIEW BY LANDSCAPE ARCHITECT PRIOR TO ORDERING.
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5. LIGHT LOCATIONS FOR REFERENCE ONLY. SEE LIGHTING PLANS FOR LOCATION AND PRODUCT INFORMATION AND DETAILS.
6. THESE NOTES APPLY TO ALL SHEETS IN THE L-200 SERIES

FILE NAME: X:\21900 PROJECTS\21906 (FRANKFORT 2ND STREET)\AUTOCAD\03_DD\L-201 FURNISHING PLAN - AREA 1.DWG

USER: kyan
DATE PLOTTED: March 12, 2020

E-SHEET NAME:

Power InRoads v8.11.7.443

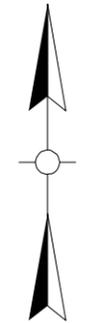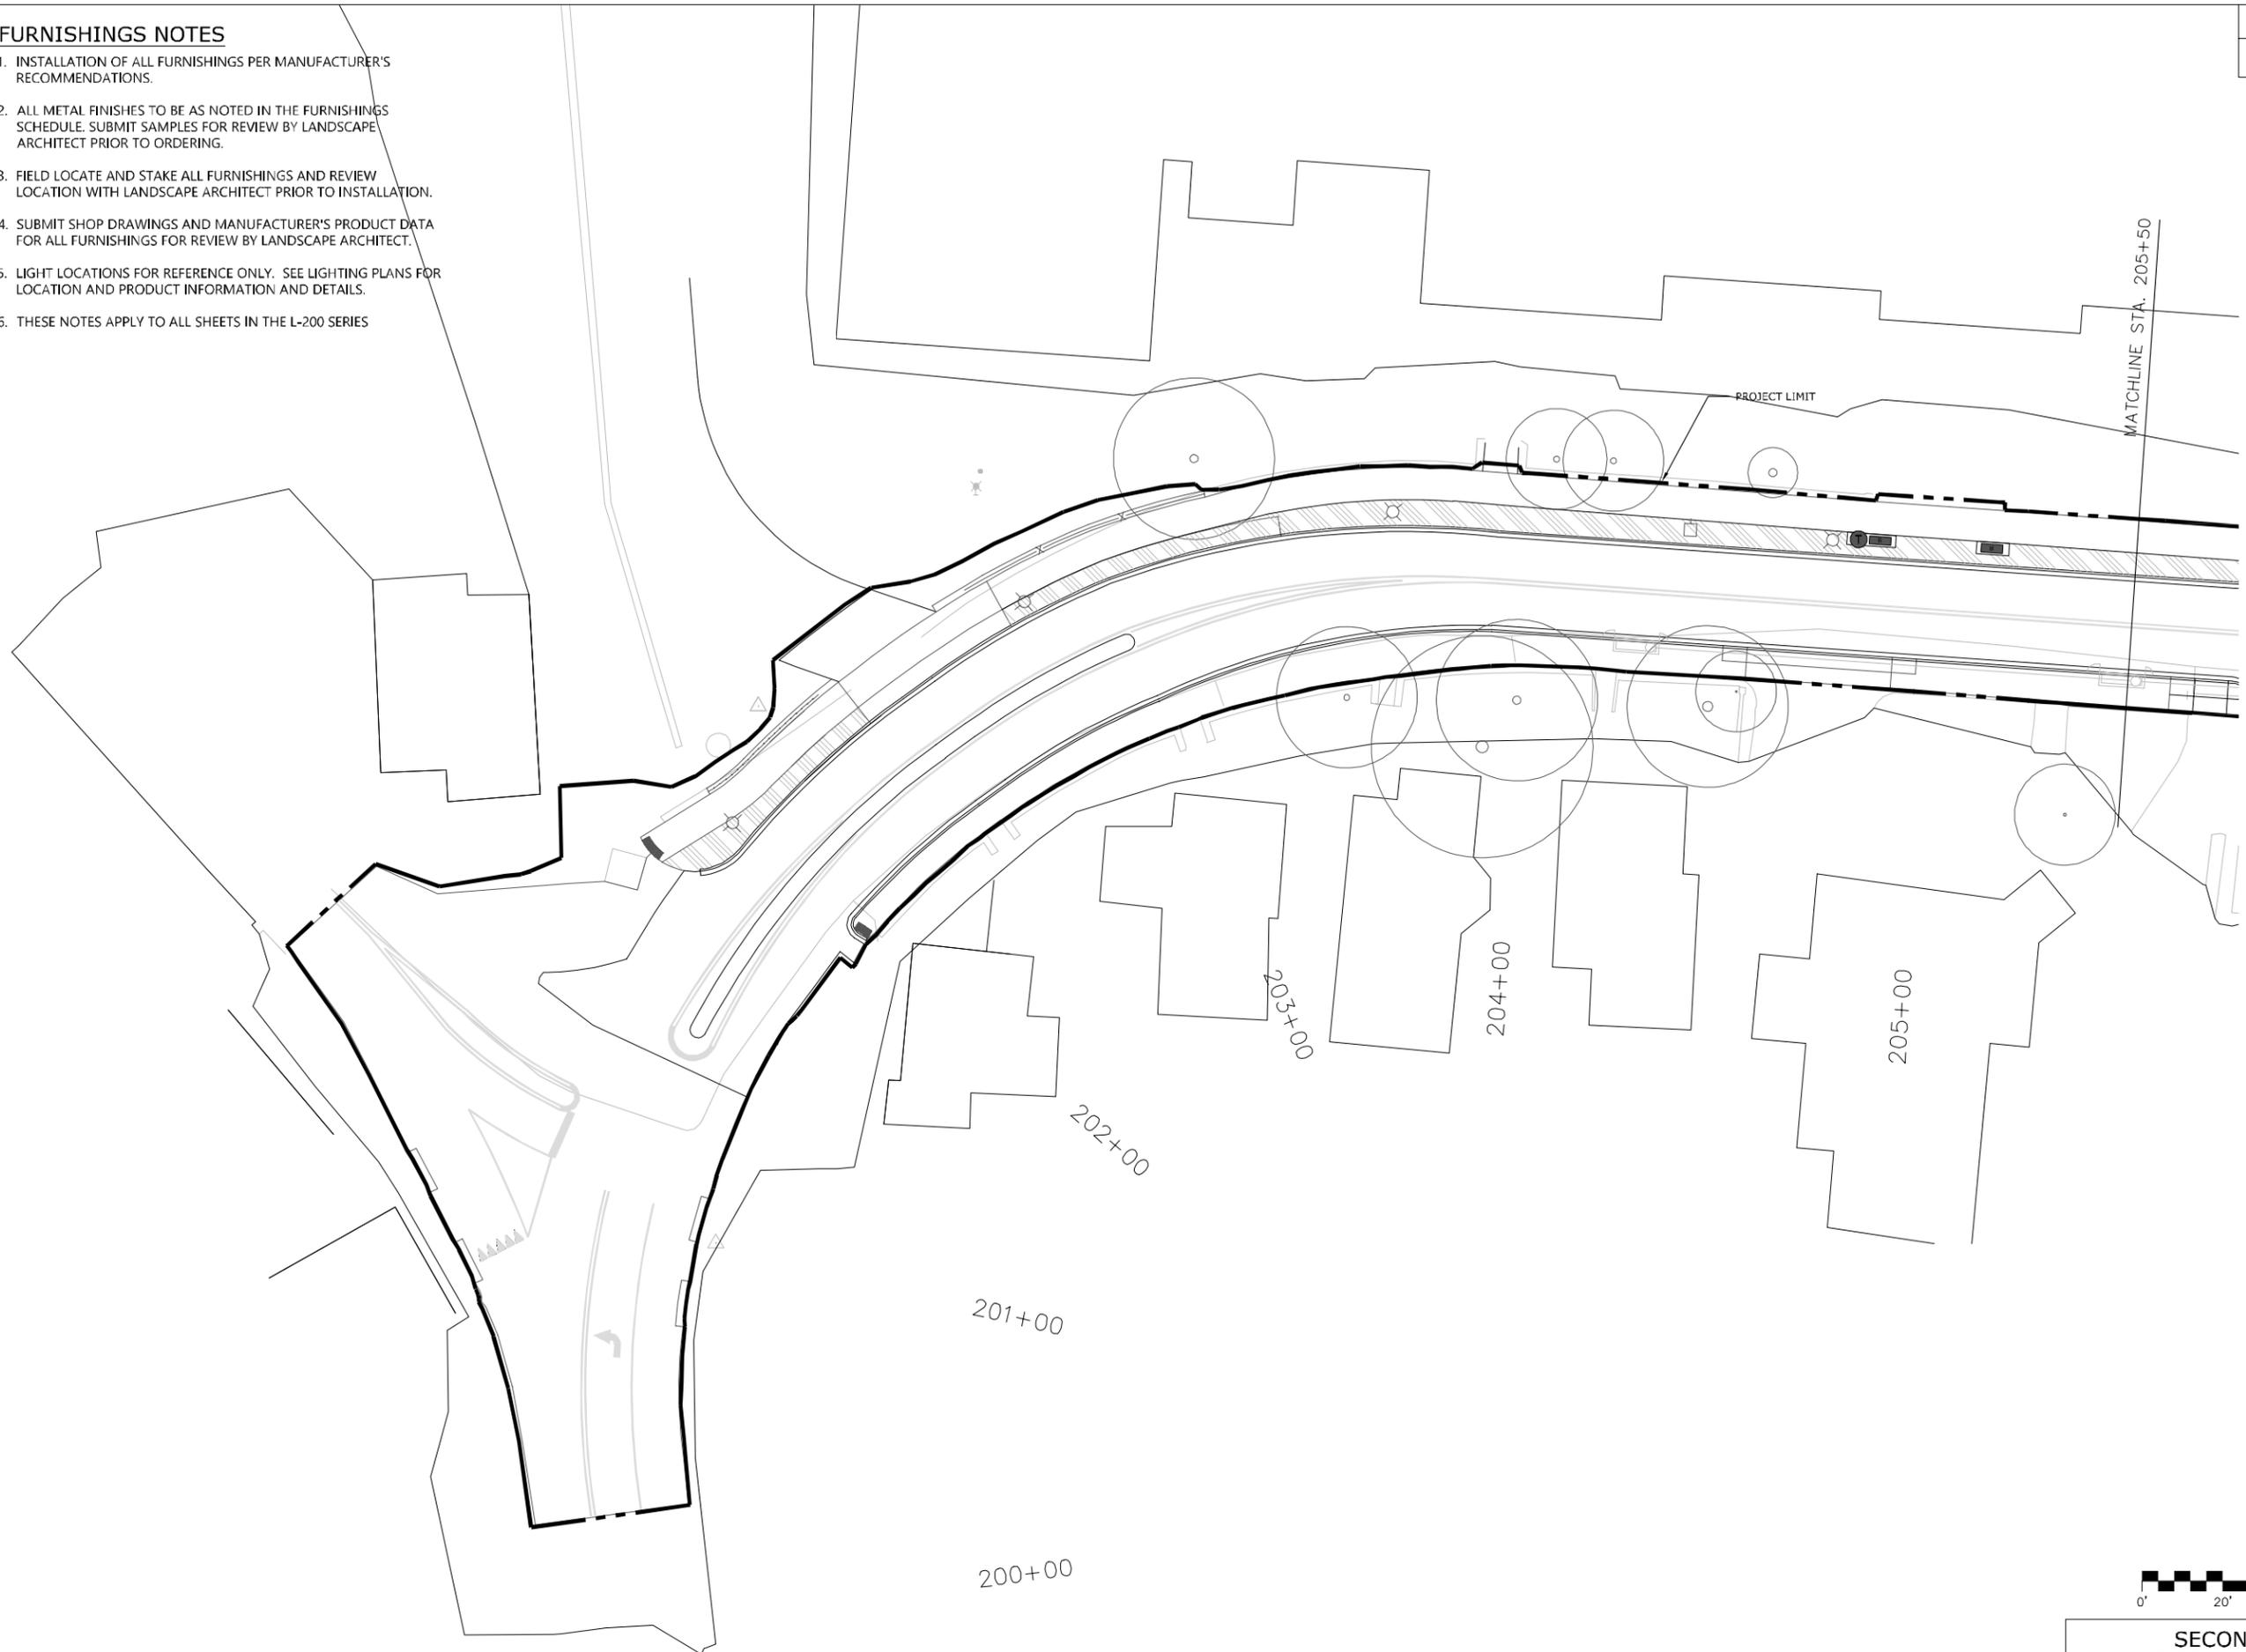

SITE FURNISHINGS SCHEDULE	
KEY	ITEM
↑ ↑ ↑	BIKE RACK
▬	BENCH
●	TRASH RECEPTACLE
⊙	PLANTER POT



SCALE: 1"=20'


**SECOND STREET (US 60)
BEGINNING TO STA.205+50
FURNISHING PLAN - AREA 1**

FILE NAME: X:\21900 PROJECTS\21906 (FRANKFORT 2ND STREET)\AUTOCAD\03_DD\L-202 FURNISHING PLAN - AREA 2.DWG

USER: kyan
DATE PLOTTED: March 11, 2020

E-SHEET NAME:

Power InRoads v8.11.7.443

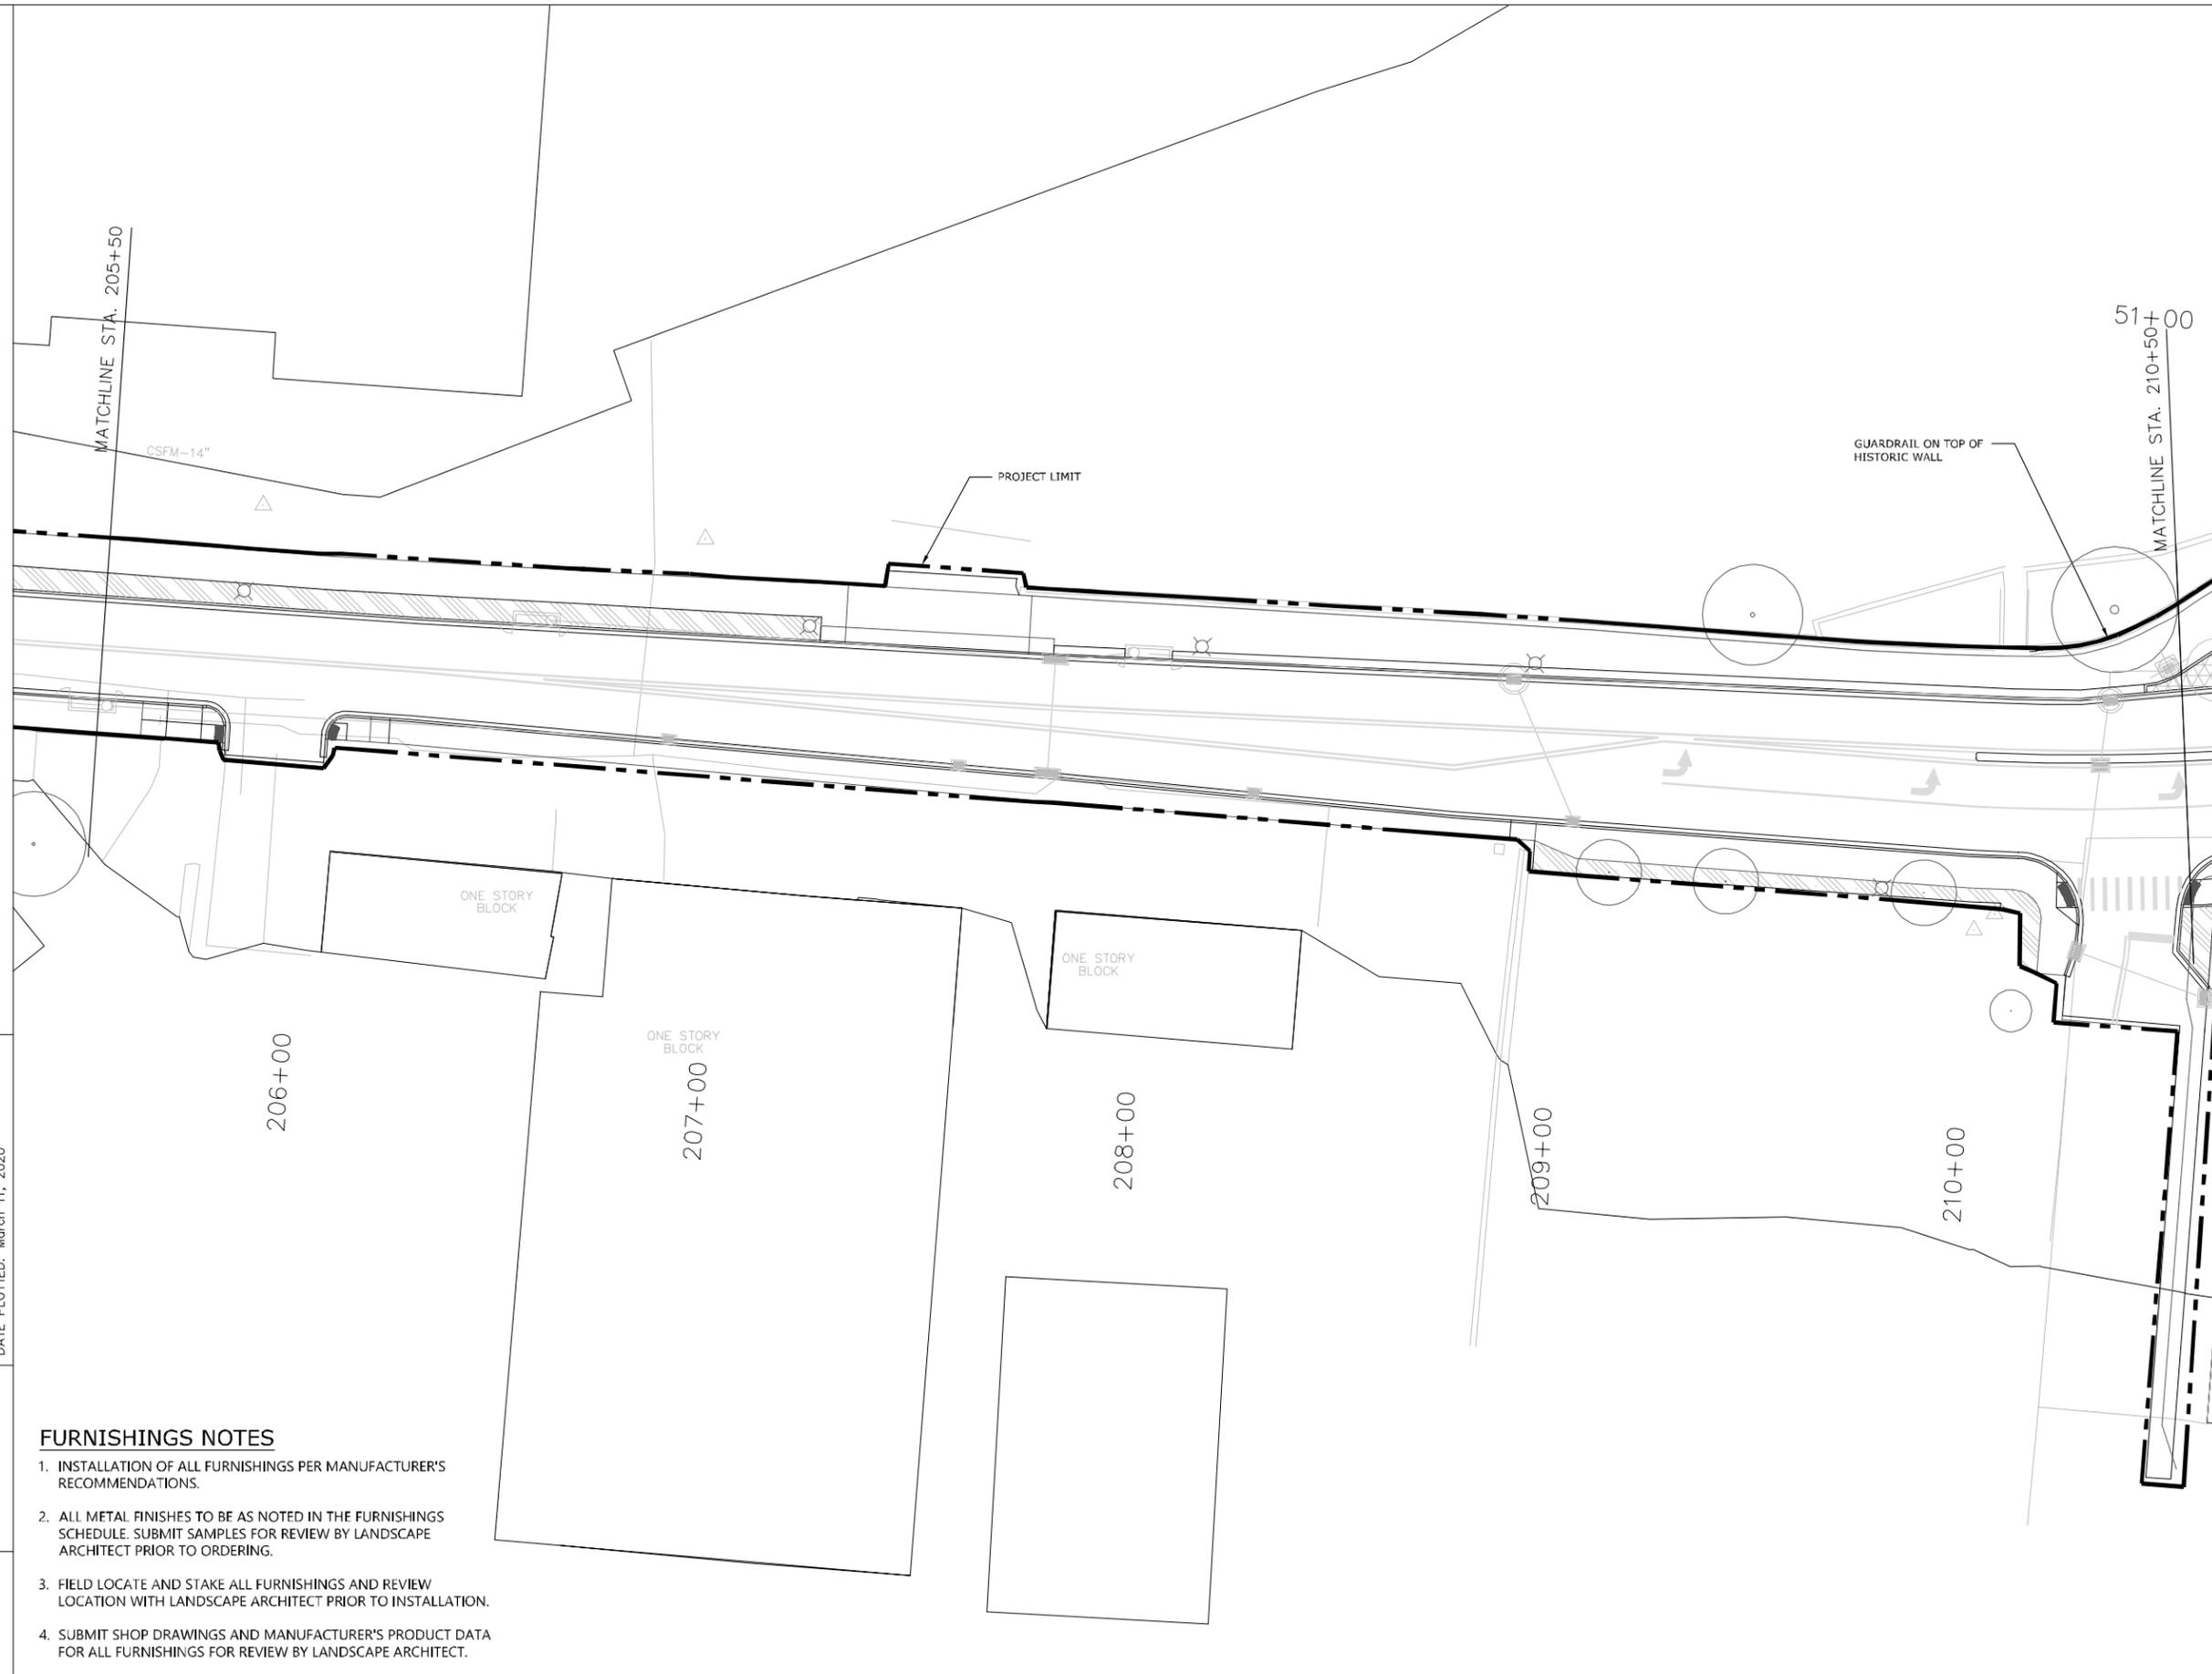

FURNISHINGS NOTES

1. INSTALLATION OF ALL FURNISHINGS PER MANUFACTURER'S RECOMMENDATIONS.
2. ALL METAL FINISHES TO BE AS NOTED IN THE FURNISHINGS SCHEDULE. SUBMIT SAMPLES FOR REVIEW BY LANDSCAPE ARCHITECT PRIOR TO ORDERING.
3. FIELD LOCATE AND STAKE ALL FURNISHINGS AND REVIEW LOCATION WITH LANDSCAPE ARCHITECT PRIOR TO INSTALLATION.
4. SUBMIT SHOP DRAWINGS AND MANUFACTURER'S PRODUCT DATA FOR ALL FURNISHINGS FOR REVIEW BY LANDSCAPE ARCHITECT.
5. LIGHT LOCATIONS FOR REFERENCE ONLY. SEE LIGHTING PLANS FOR LOCATION AND PRODUCT INFORMATION AND DETAILS.
6. THESE NOTES APPLY TO ALL SHEETS IN THE L-200 SERIES

SITE FURNISHINGS SCHEDULE	
KEY	ITEM
↑↑↑	BIKE RACK
■	BENCH
⊙	TRASH RECEPTACLE
⊕	PLANTER POT





SCALE: 1"=20'

SECOND STREET (US 60)
STA. 205+50 TO STA. 210+50
FURNISHING PLAN - AREA 2

COUNTY OF	ITEM NO.	SHEET NO.
FRANKLIN	5-565	L-203


FURNISHINGS NOTES

1. INSTALLATION OF ALL FURNISHINGS PER MANUFACTURER'S RECOMMENDATIONS.
2. ALL METAL FINISHES TO BE AS NOTED IN THE FURNISHINGS SCHEDULE. SUBMIT SAMPLES FOR REVIEW BY LANDSCAPE ARCHITECT PRIOR TO ORDERING.
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6. THESE NOTES APPLY TO ALL SHEETS IN THE L-200 SERIES

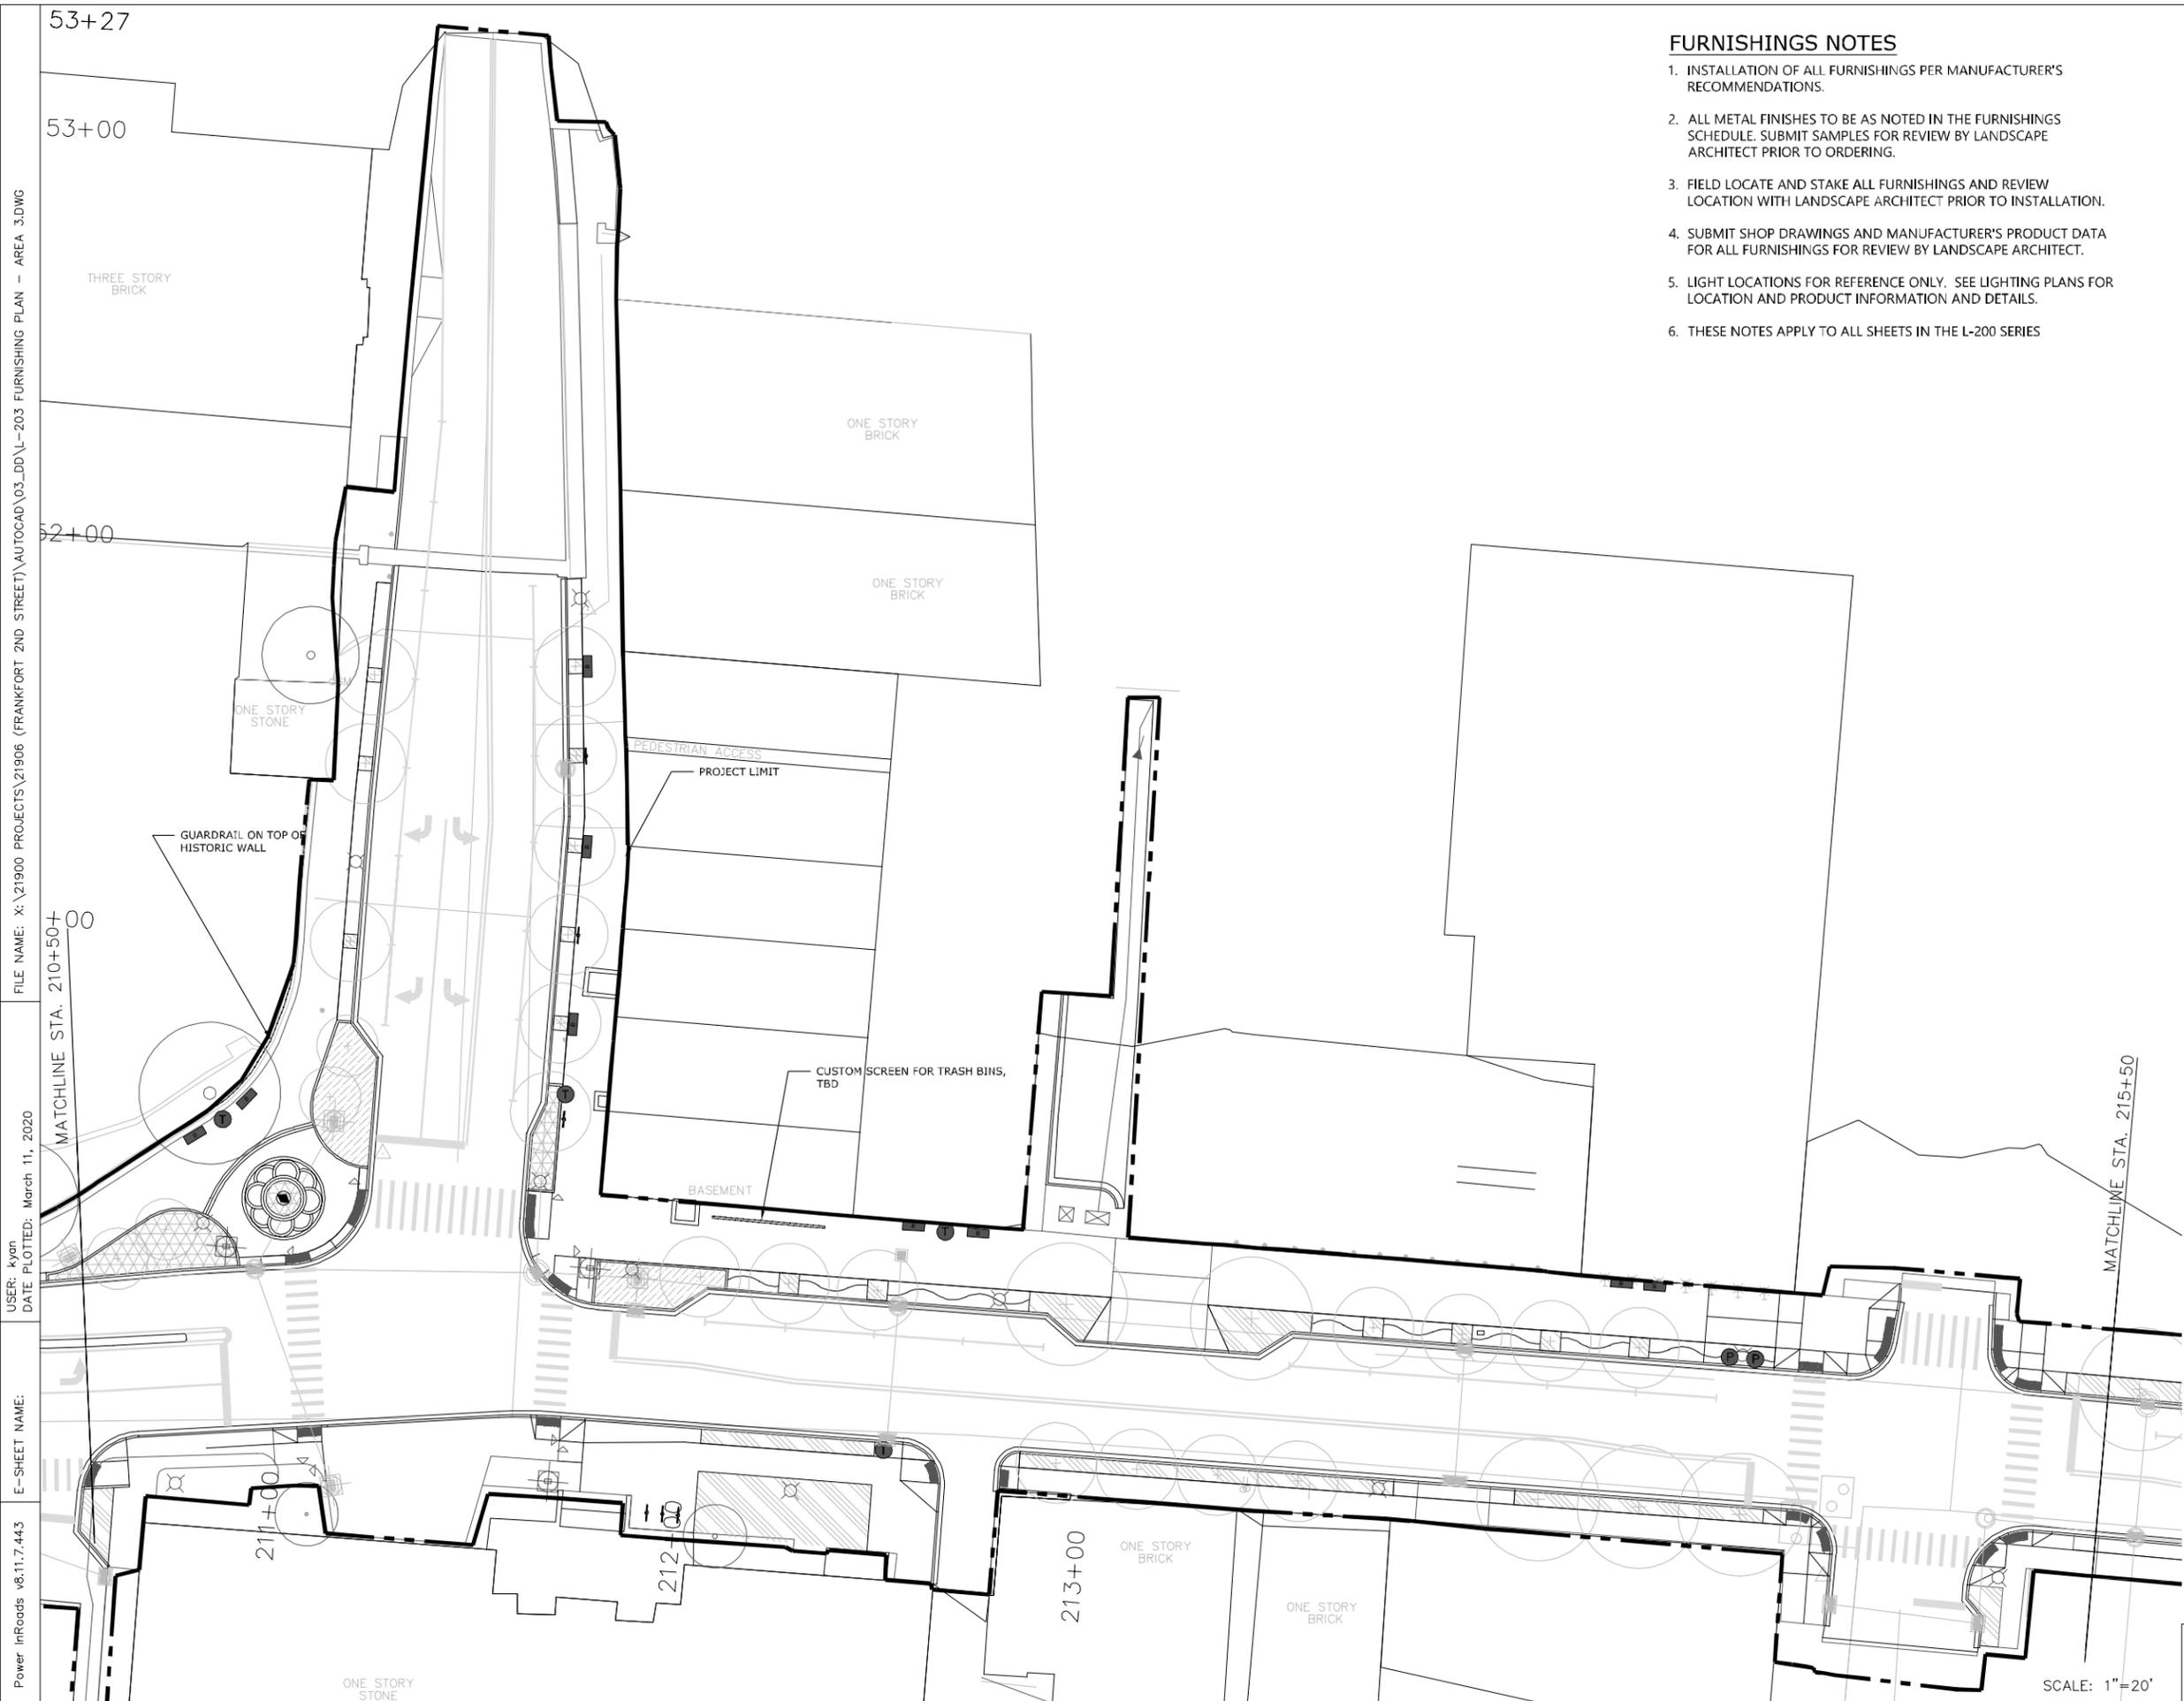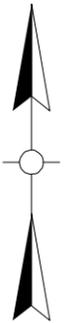

SITE FURNISHINGS SCHEDULE

KEY	ITEM
↑↑↑	BIKE RACK
■	BENCH
●	TRASH RECEPTACLE
●	PLANTER POT

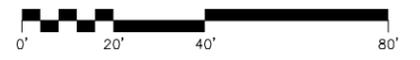

SCALE: 1"=20'

SECOND STREET (US 60) STA. 210+50 TO STA. 215+50 & BRIDGE STREET FURNISHING PLAN - AREA 3

FILE NAME: X:\21900 PROJECTS\21906 (FRANKFORT 2ND STREET)\AUTOCAD\03_DD\L-203 FURNISHING PLAN - AREA 3.DWG
 USER: kyon
 DATE PLOTTED: March 11, 2020
 E-SHEET NAME:
 Power InRoads v8.11.7.443

FURNISHINGS NOTES

1. INSTALLATION OF ALL FURNISHINGS PER MANUFACTURER'S RECOMMENDATIONS.
2. ALL METAL FINISHES TO BE AS NOTED IN THE FURNISHINGS SCHEDULE. SUBMIT SAMPLES FOR REVIEW BY LANDSCAPE ARCHITECT PRIOR TO ORDERING.
3. FIELD LOCATE AND STAKE ALL FURNISHINGS AND REVIEW LOCATION WITH LANDSCAPE ARCHITECT PRIOR TO INSTALLATION.
4. SUBMIT SHOP DRAWINGS AND MANUFACTURER'S PRODUCT DATA FOR ALL FURNISHINGS FOR REVIEW BY LANDSCAPE ARCHITECT.
5. LIGHT LOCATIONS FOR REFERENCE ONLY. SEE LIGHTING PLANS FOR LOCATION AND PRODUCT INFORMATION AND DETAILS.
6. THESE NOTES APPLY TO ALL SHEETS IN THE L-200 SERIES



COUNTY OF	ITEM NO.	SHEET NO.
FRANKLIN	5-565	L-204

FILE NAME: X:\21900 PROJECTS\21906 (FRANKFORT 2ND STREET)\AUTOCAD\03_DD\L-204 FURNISHING PLAN - AREA 4.DWG

USER: kyon
DATE PLOTTED: March 11, 2020

E-SHEET NAME:

Power InRoads v8.11.7.443

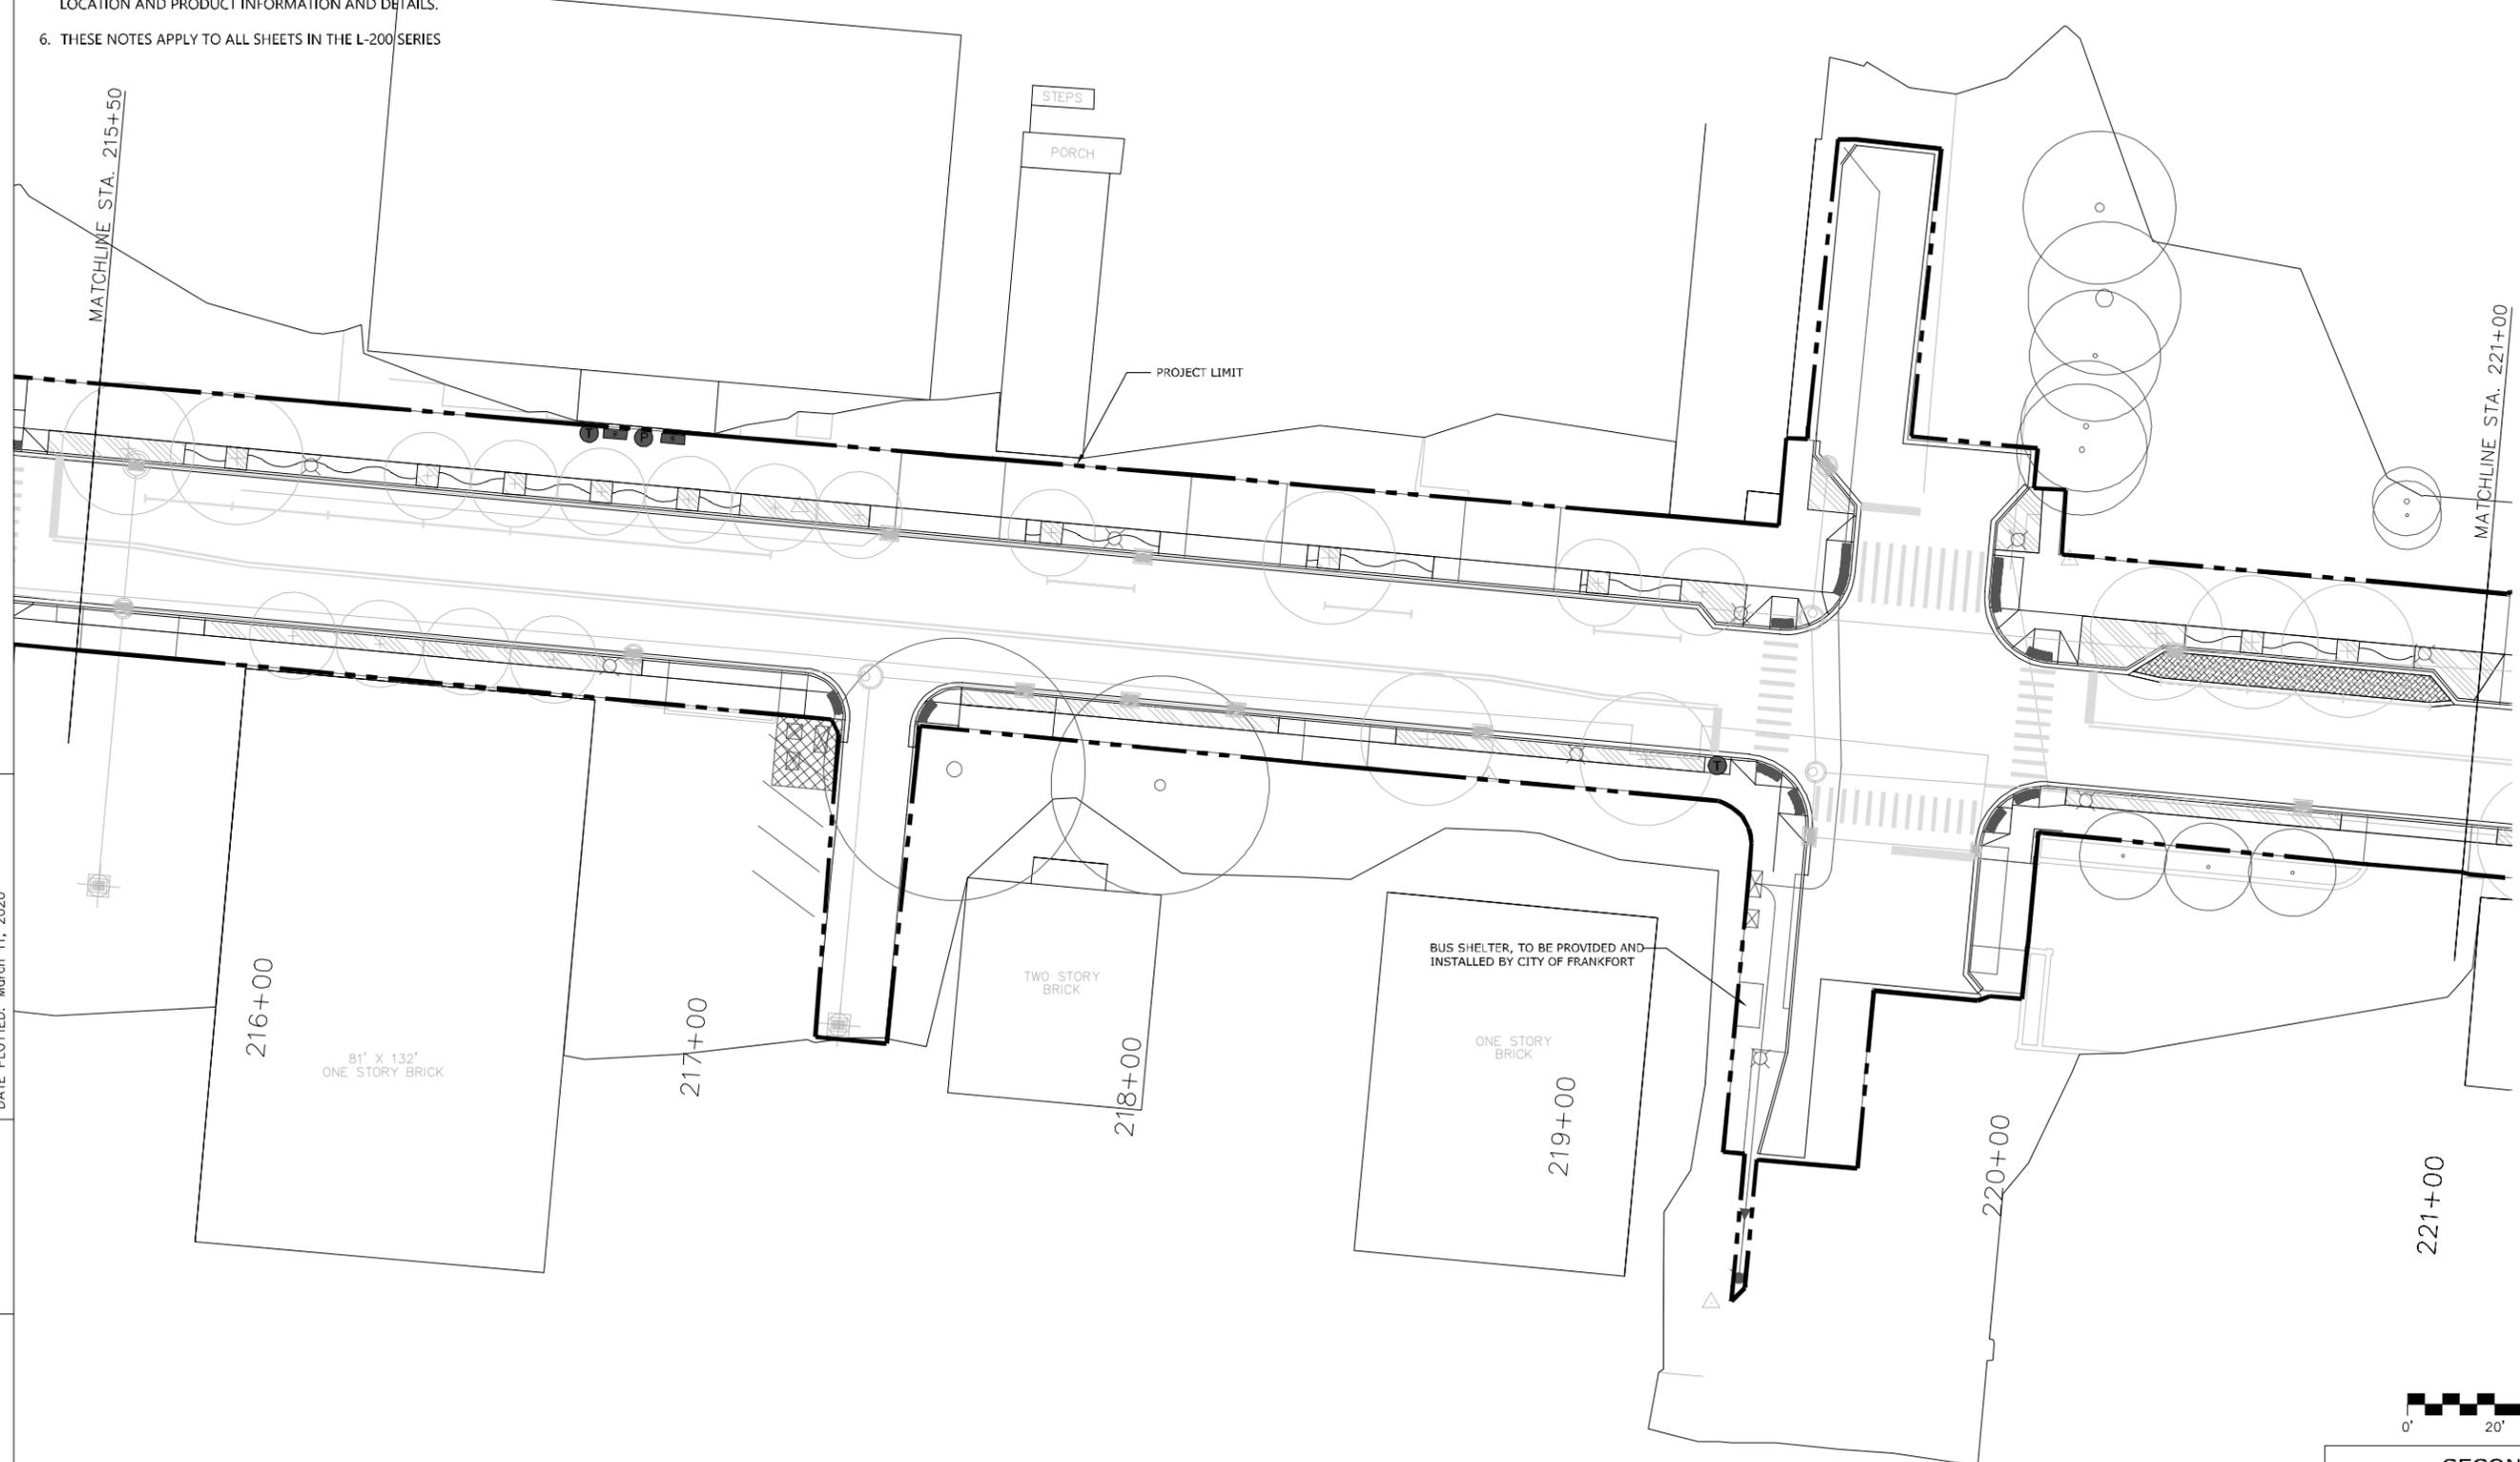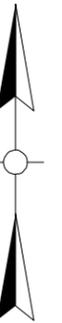

SITE FURNISHINGS SCHEDULE

KEY	ITEM
↑ ↑ ↑	BIKE RACK
■	BENCH
●	TRASH RECEPTACLE
●	PLANTER POT




SCALE: 1"=20'

SECOND STREET (US 60)
STA. 215+50 TO STA. 221+00
FURNISHING PLAN - AREA 4


FURNISHINGS NOTES

1. INSTALLATION OF ALL FURNISHINGS PER MANUFACTURER'S RECOMMENDATIONS.
2. ALL METAL FINISHES TO BE AS NOTED IN THE FURNISHINGS SCHEDULE. SUBMIT SAMPLES FOR REVIEW BY LANDSCAPE ARCHITECT PRIOR TO ORDERING.
3. FIELD LOCATE AND STAKE ALL FURNISHINGS AND REVIEW LOCATION WITH LANDSCAPE ARCHITECT PRIOR TO INSTALLATION.
4. SUBMIT SHOP DRAWINGS AND MANUFACTURER'S PRODUCT DATA FOR ALL FURNISHINGS FOR REVIEW BY LANDSCAPE ARCHITECT.
5. LIGHT LOCATIONS FOR REFERENCE ONLY. SEE LIGHTING PLANS FOR LOCATION AND PRODUCT INFORMATION AND DETAILS.
6. THESE NOTES APPLY TO ALL SHEETS IN THE L-200 SERIES

COUNTY OF	ITEM NO.	SHEET NO.
FRANKLIN	5-565	L-205

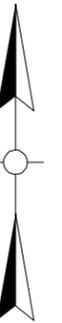

FILE NAME: X:\21900 PROJECTS\21906 (FRANKFORT 2ND STREET)\AUTOCAD\03_DD\L-205 FURNISHING PLAN - AREA 5.DWG
 USER: kyan
 DATE PLOTTED: March 11, 2020
 E-SHEET NAME: Power InRoads v8.11.7.443

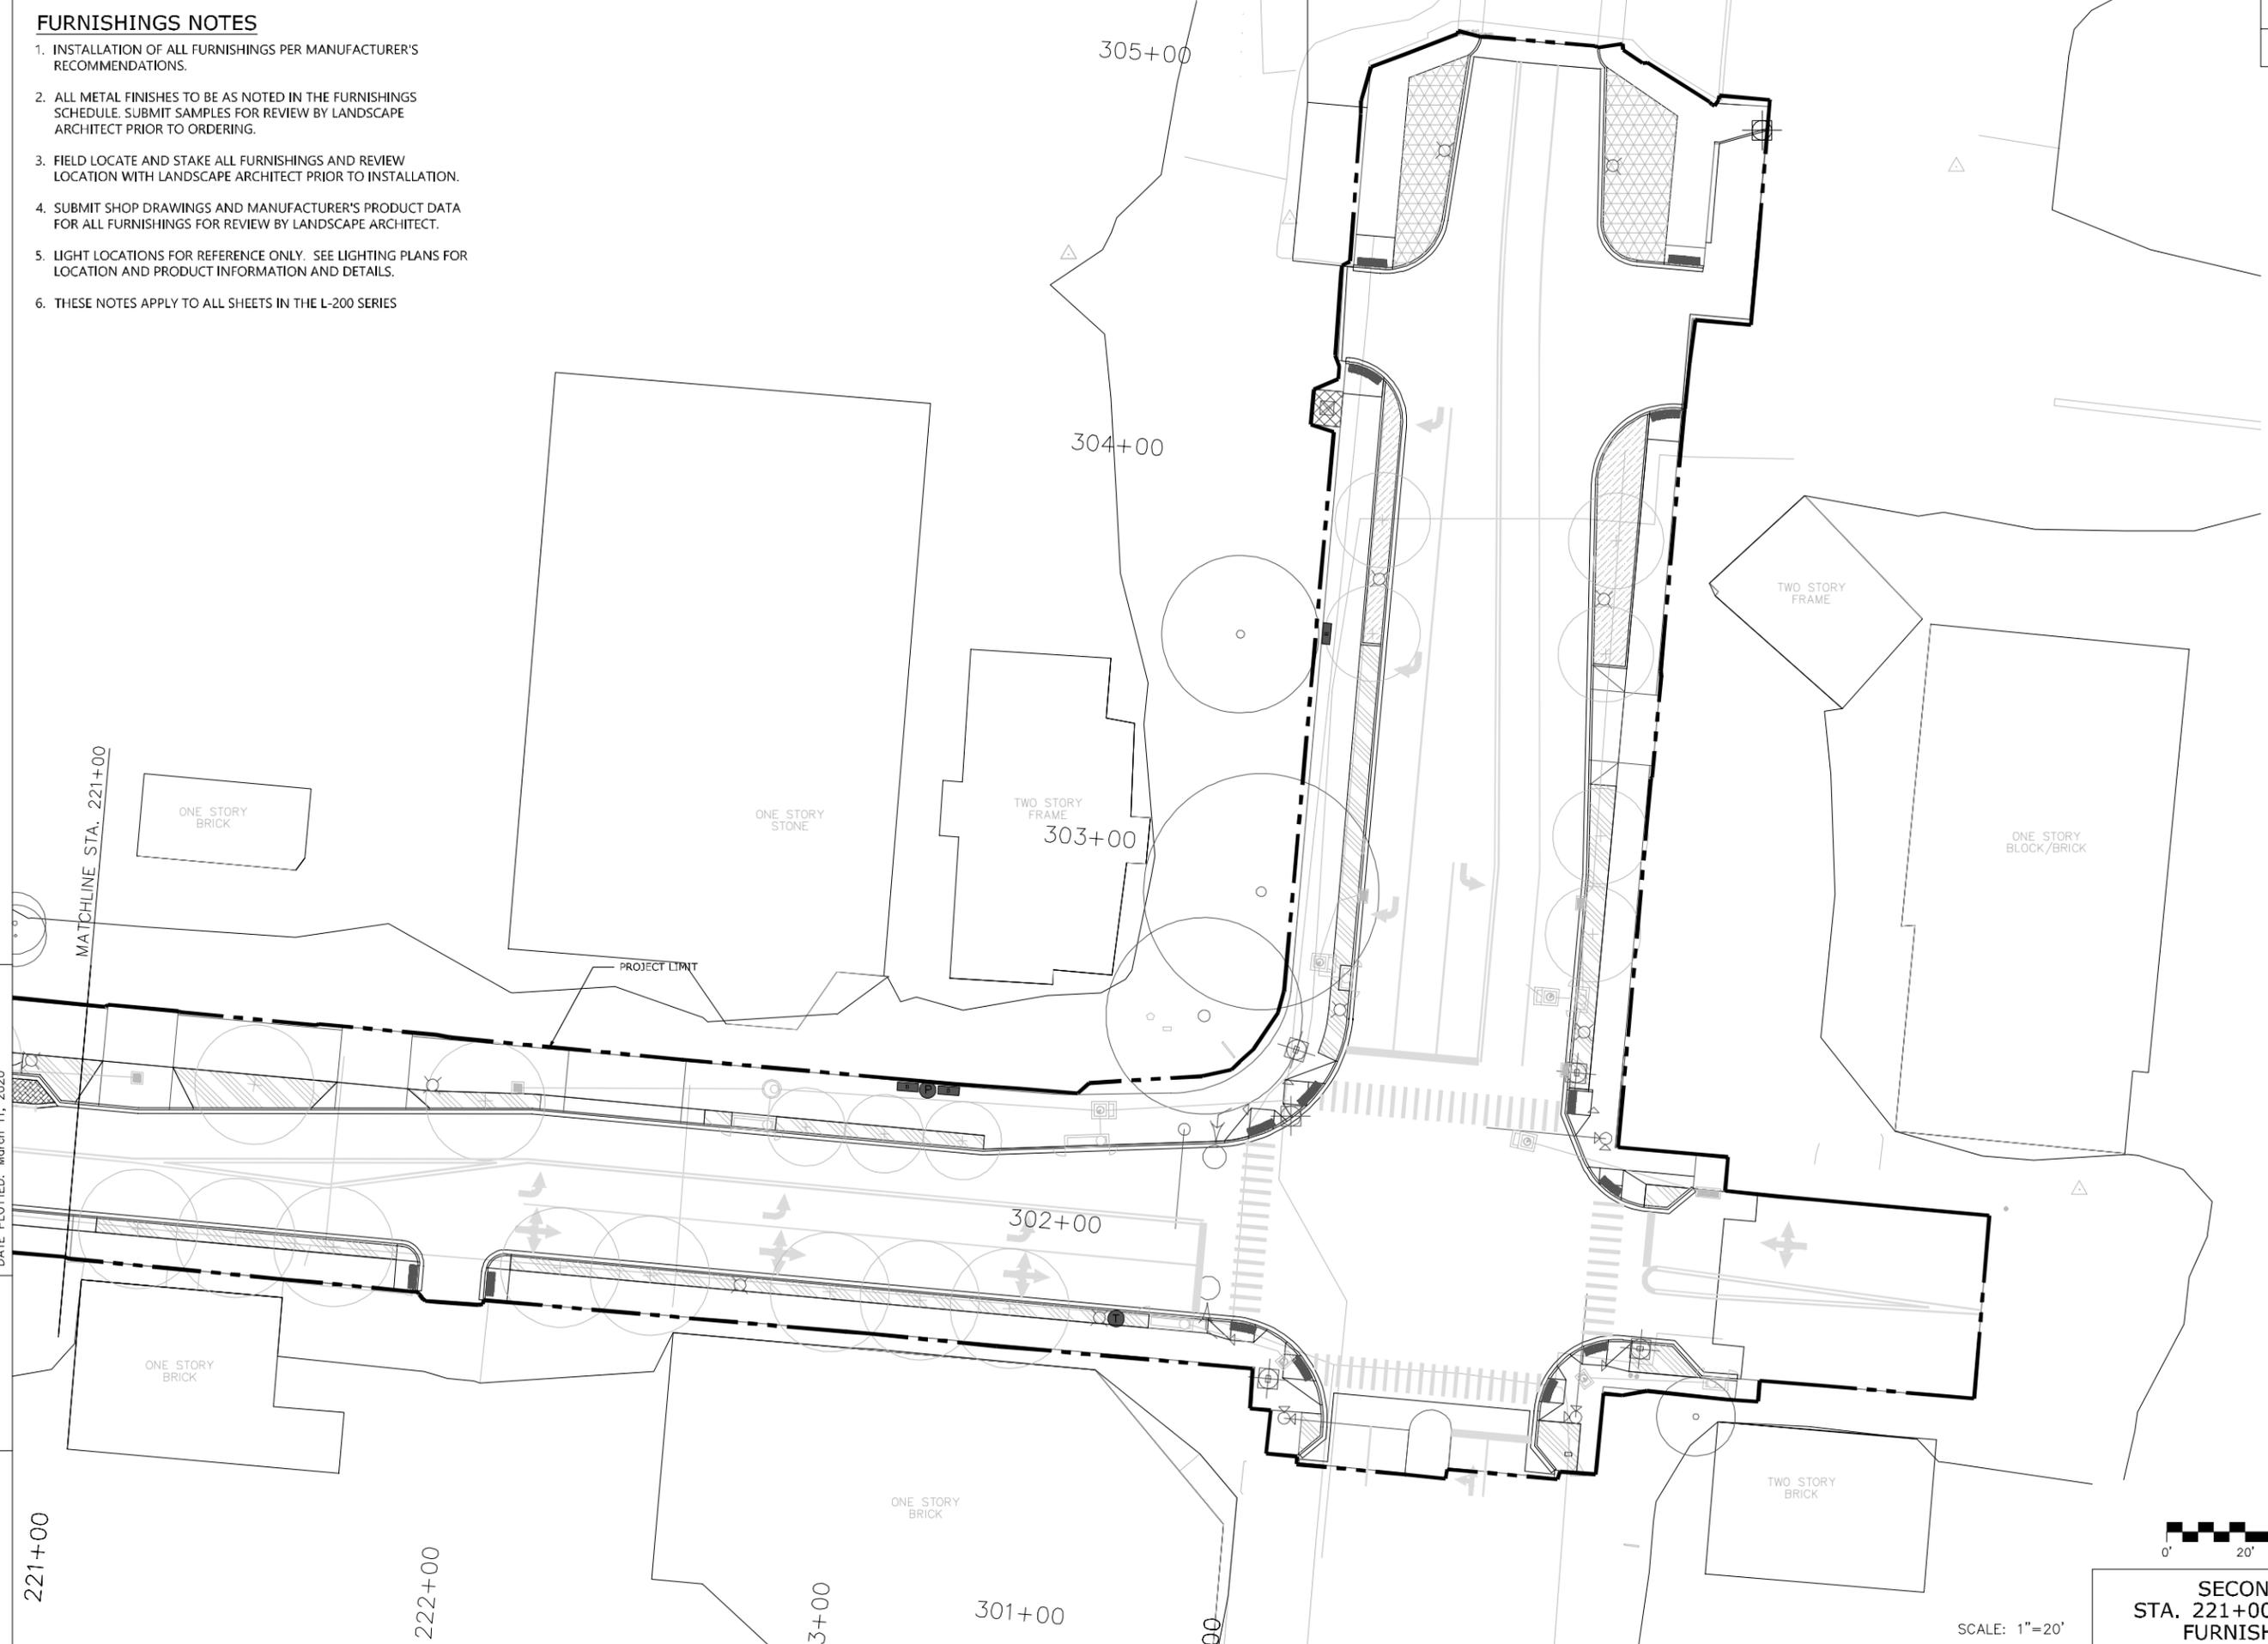

SITE FURNISHINGS SCHEDULE

KEY	ITEM
↑↑↑	BIKE RACK
■	BENCH
⊙	TRASH RECEPTACLE
⊕	PLANTER POT





SCALE: 1"=20'
 SECOND STREET (US 60)
 STA. 221+00 TO END & CAPITAL AVE
 FURNISHING PLAN - AREA 5

Power InRoads v8.11.7.443 E-SHEET NAME: USER: kyan DATE PLOTTED: March 11, 2020 FILE NAME: X:\21900 PROJECTS\21906 (FRANKFORT 2ND STREET)\AUTOCAD\03_DD\L-206 FURNISHING PLAN - AREA 6 & 7.DWG


COUNTY OF	ITEM NO.	SHEET NO.
FRANKLIN	5-565	L-206

FURNISHINGS NOTES

1. INSTALLATION OF ALL FURNISHINGS PER MANUFACTURER'S RECOMMENDATIONS.
2. ALL METAL FINISHES TO BE AS NOTED IN THE FURNISHINGS SCHEDULE. SUBMIT SAMPLES FOR REVIEW BY LANDSCAPE ARCHITECT PRIOR TO ORDERING.
3. FIELD LOCATE AND STAKE ALL FURNISHINGS AND REVIEW LOCATION WITH LANDSCAPE ARCHITECT PRIOR TO INSTALLATION.
4. SUBMIT SHOP DRAWINGS AND MANUFACTURER'S PRODUCT DATA FOR ALL FURNISHINGS FOR REVIEW BY LANDSCAPE ARCHITECT.
5. LIGHT LOCATIONS FOR REFERENCE ONLY. SEE LIGHTING PLANS FOR LOCATION AND PRODUCT INFORMATION AND DETAILS.
6. THESE NOTES APPLY TO ALL SHEETS IN THE L-200 SERIES

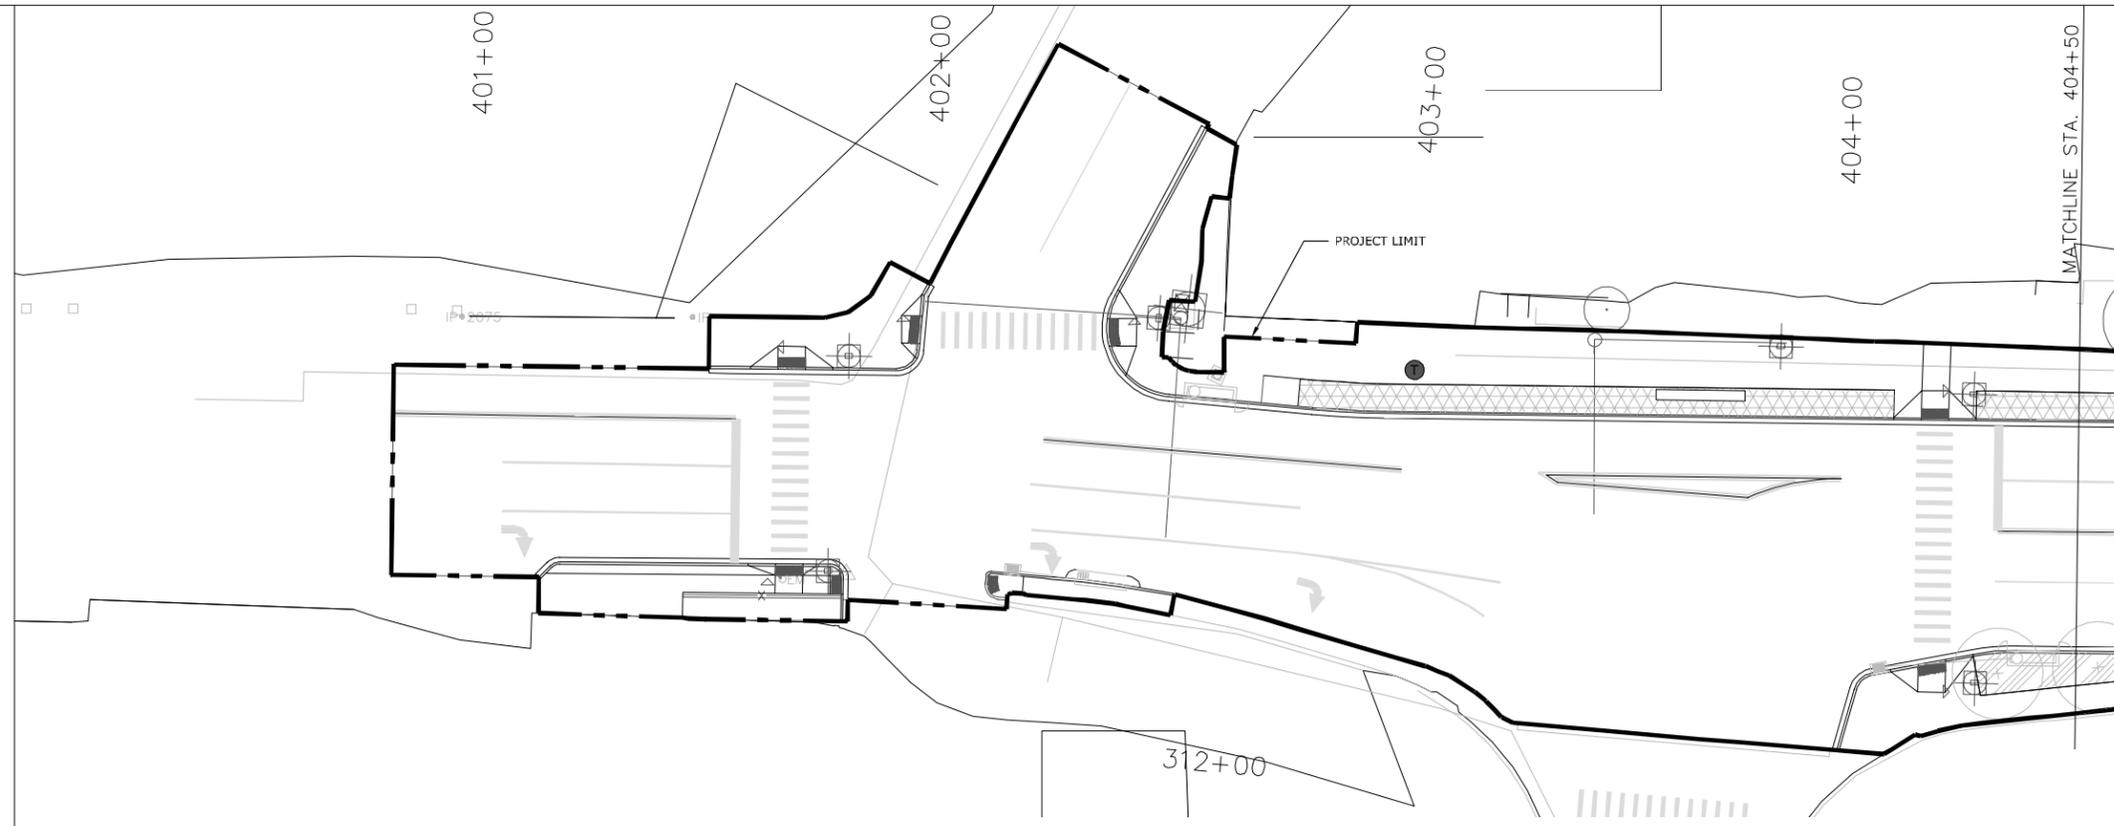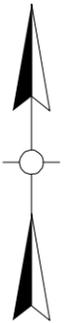

1 MAIN STREET (BEGINNING TO STA. 404+50)
SCALE: 1" = 20'

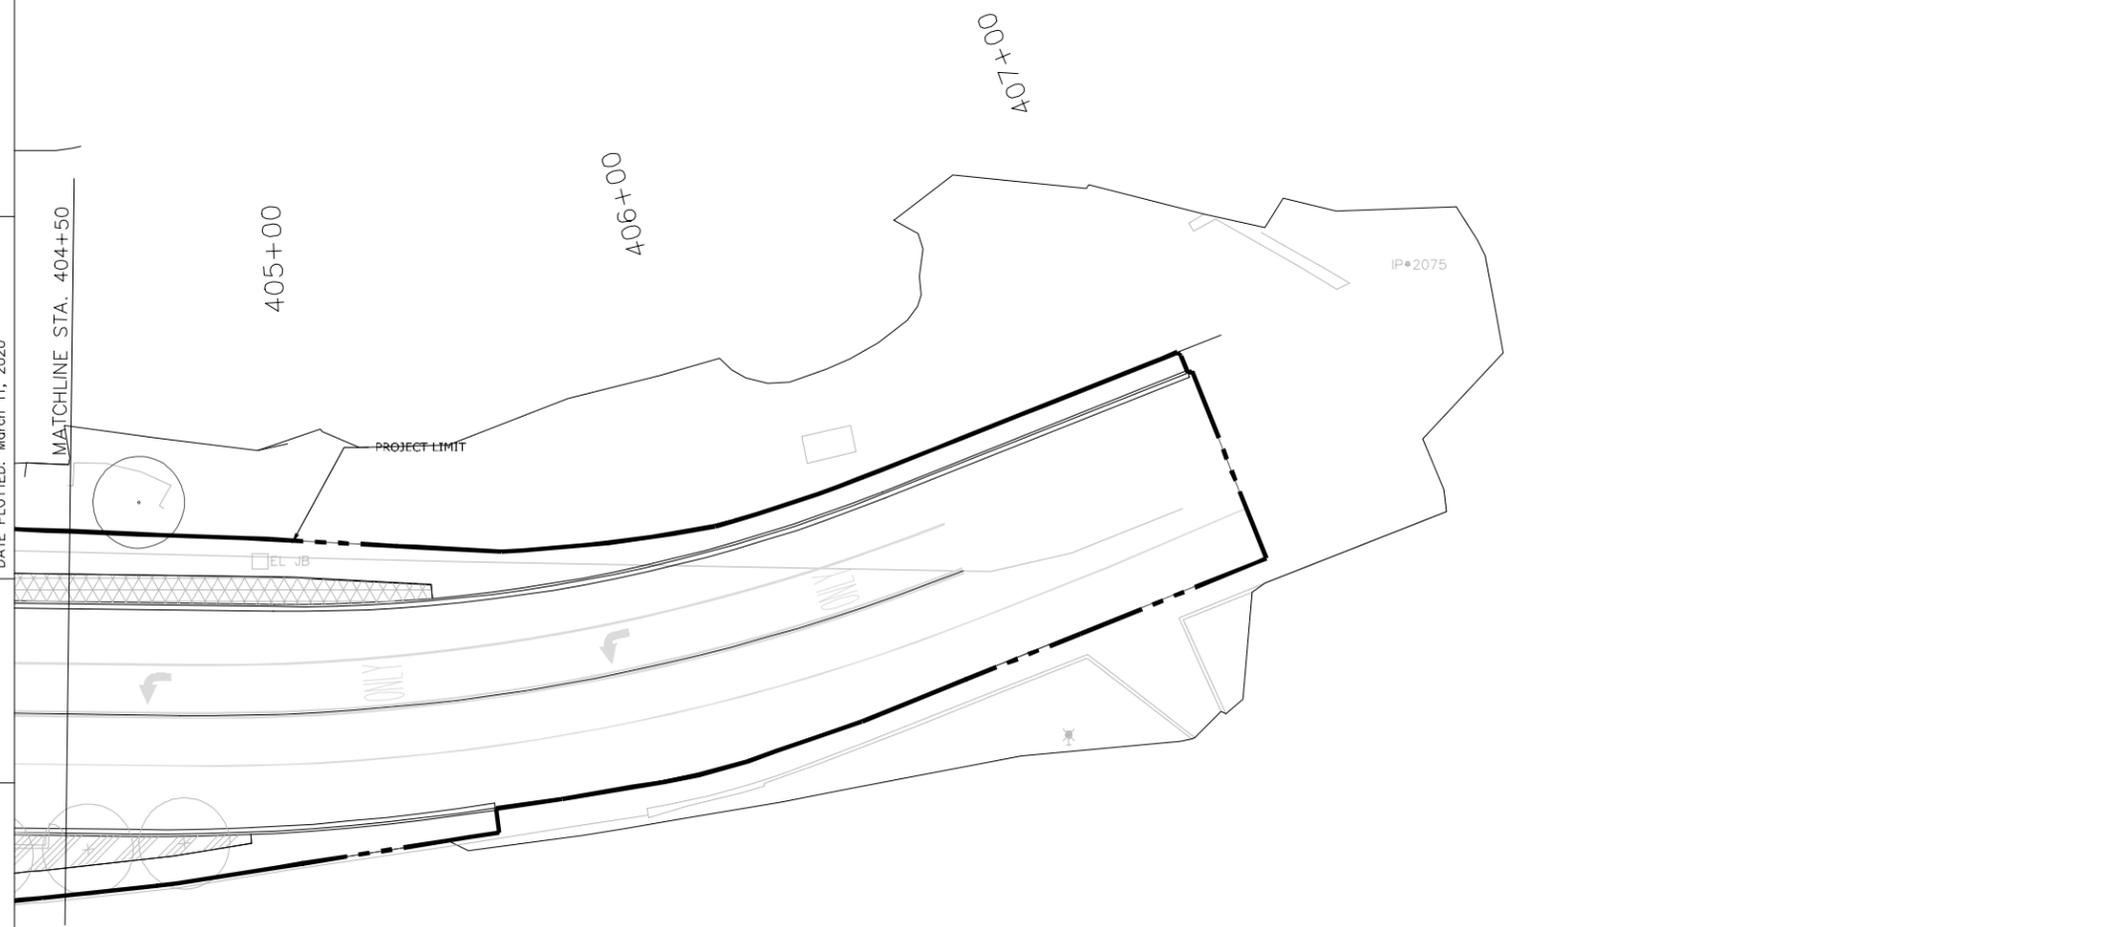

2 MAIN STREET (STA. 404+50 TO END.)
SCALE: 1" = 20'

SITE FURNISHINGS SCHEDULE	
KEY	ITEM
↑ ↑ ↑	BIKE RACK
■	BENCH
⊙	TRASH RECEPTACLE
⊕	PLANTER POT



MAIN STREET (US 60/ KY 420)
BEGINNING TO END.
FURNISHING PLAN - AREA 6 & 7

SCALE: 1"=20'

COUNTY OF	ITEM NO.	SHEET NO.
FRANKLIN	5-565	L-207




Allure Bike Rack
 Bike Rack Color: Textured Pewter
 Item №: AL19BR2
 Dimensions: 33"H x 5"W x 13"L
 Weight: 14 lbs
 Manufacture: ANOVA
 Contact: JULIE NASH (OH, KY)
 614-581-6399
 julie.n@anovafurnishings.com

1 BIKE RACK
 SCALE: NTS



Airi Leaf 6' Contour Bench
 Frame Color: Textured Pewter
 Seat Color: Blue
 Item №: AE2680LF
 Dimensions: 35"H x 23"W x 75"L
 Weight: 143 lbs
 Manufacture: ANOVA
 Contact: JULIE NASH (OH, KY)
 614-581-6399
 julie.n@anovafurnishings.com

2 BENCH
 SCALE: NTS

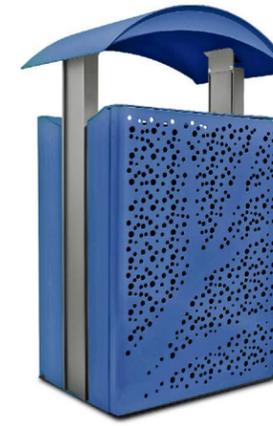

Airi Leaf 45-Gal. Trash Receptacle w/Side Door, Curve Top
 Panel / Lid Color: Blue
 Frame Color: Textured Pewter
 Label (1): Trash (white Lettering)
 Item №: AE2645CBT-LF
 Dimensions: 50"H x 26"W x 22"D
 Weight: 200 lbs
 Manufacture: ANOVA
 Contact: JULIE NASH (OH, KY)
 614-581-6399
 julie.n@anovafurnishings.com

3 TRASH RECEPTACLE
 SCALE: NTS



Model: Lakeside Planter (Leaf Pattern)
 Size: 36" diameter x 23" height
 Metal Color: TBD
 Liner Color: TBD
 Manufacture: Landscape Forms
 Contact: Kendra Brown
 Office: 269-276-4440
 Mobile: 614-558-2800
 kendrab@landscapeforms.com
 www.landscapeforms.com

4 PLANTERS
 SCALE: NTS

FILE NAME: X:\21900 PROJECTS\21906 (FRANKFORT 2ND STREET)\AUTOCAD\03_DD\L-207 FURNISHING DETAILS.DWG

USER: kyan
 DATE PLOTTED: March 11, 2020

E-SHEET NAME:

Power InRoads v8.11.7.443



PLANT SCHEDULE

KEY	SPECIES	SIZE	NOTES
TREES			
AL	<i>Amelanchier laevis</i> 'Cumulus' Cumulus Allegheny Serviceberry	2" CAL	B&B, SPECIMEN
GB	<i>Ginkgo biloba</i> 'Princeton Sentry' Princeton Sentry Ginkgo	2.5" CAL	B&B, SPECIMEN
TA	<i>Tilia americana</i> 'McKSentry' American Sentry Linden	2.5" CAL	B&B, SPECIMEN
QB	<i>Quercus bicolor</i> 'JFS-KW12' American Dream Swamp White Oak	2.5" CAL	B&B, SPECIMEN
GREEN INFRASTRUCTURE SHRUBS & PERENNIALS			
AM	<i>Aronia melanocarpa</i> 'Low Scape Mound' Low Scape Mound Black Chokeberry	#1 CONT	18" O.C.
CO	<i>Coreopsis verticillata</i> 'Zagreb' Zagreb Threadleaf Tickseed	#1 CONT	18" O.C.
PV	<i>Panicum virgatum</i> 'Prairie Winds Cheyenne Sky' Prairie Winds@ 'Cheyenne Sky' Switch Grass	#1 CONT	18" O.C.
SO	<i>Symphoricarpos orbiculatus</i> 'Proud Berry' Proud Berry Coral Berry	#3 CONT	3' O.C.
STREET EDGE LANDSCAPE SHRUBS & PERENNIALS			
AM	<i>Aronia melanocarpa</i> 'Low Scape Mound' Low Scape Mound Black Chokeberry	#1 CONT	18" O.C.
ES	<i>Eragrostis spectabilis</i> Purple Love Grass	#1 CONT	18" O.C.
PV	<i>Panicum virgatum</i> 'Prairie Winds Cheyenne Sky' Prairie Winds@ 'Cheyenne Sky' Switch Grass	#1 CONT	18" O.C.
RF	<i>Rudbeckia fulgida</i> Orange Coneflower	#1 CONT	18" O.C.
GATEWAY LANDSCAPE SHRUBS & PERENNIALS			
AM	<i>Aronia melanocarpa</i> 'Low Scape Mound' Low Scape Mound Black Chokeberry	#1 CONT	18" O.C.
CA	<i>Ceanothus americanus</i> New Jersey Tea	#3 CONT	2.5' O.C.
CO	<i>Coreopsis verticillata</i> 'Zagreb' Zagreb Threadleaf Tickseed	#1 CONT	18" O.C.
ES	<i>Eragrostis spectabilis</i> Purple Love Grass	#1 CONT	18" O.C.
RF	<i>Rudbeckia fulgida</i> Orange Coneflower	#1 CONT	18" O.C.
SS	<i>Schizachyrium scoparium</i> 'The Blues' The Blues Little Bluestem	#1 CONT	18" O.C.

KEY	ITEM	SUPPLIER	NOTES	QUANTITY
SC	SILVA CELLS	DeepRoot Green Infrastructure, LLC 101 Montgomery Street, Suite 2850 San Francisco, CA, 94104	Model: 2x Silva Cell System Size: 30.9" H x 23.6"W x 47.2"L See detail 4,5/L-307	187

- FINAL GRADING AND SITE PREPARATION SHALL BE COMPLETED PRIOR TO PLANTING. THIS SHOULD INCLUDE DRAINAGE PER THE GRADING PLAN, REMOVAL OF MISCELLANEOUS DEBRIS, ELIMINATION OF EXISTING PLANT MATERIAL AS DIRECTED, AND PLACEMENT OF ADDITIONAL TOPSOIL REQUIRED FOR PLANT ESTABLISHMENT.
- COORDINATE ALL ELECTRICAL UTILITIES & DRAINAGE STRUCTURES WITH PLANTINGS; CONTRACTOR TO NOTIFY OWNER AND LANDSCAPE ARCHITECT OF ANY CONFLICTS AND RESOLVE ISSUES IN THE FIELD.
- CONTRACTOR TO STAKE ALL TREE LOCATIONS & PLANTING BED LINES PRIOR TO INSTALLATION. REVIEW STAKING LOCATIONS WITH OWNER AND LANDSCAPE ARCHITECT PRIOR TO INSTALLATION.
- ALL PLANT MATERIAL SHALL BE MAINTAINED IN A HEALTHY AND GROWING CONDITION AND MUST BE REPLACED WITH PLANT MATERIAL OF SIMILAR VARIETY AND SIZE IF IT IS DEAD, DAMAGED, DESTROYED, OR REMOVED UP TO ONE YEAR AFTER INSTALLATION.
- IT IS THE RESPONSIBILITY OF THE CONTRACTOR TO ADVISE THE OWNER OF ANY CONDITION FOUND ON THE SITE WHICH PROHIBITS THE INSTALLATION OF PLANTS AS SHOWN ON THE DRAWINGS.
- PLANT SPACING IS AS INDICATED ON 'PLANT SCHEDULE' UNLESS OTHERWISE NOTED. IT IS THE CONTRACTOR'S RESPONSIBILITY TO PROVIDE FULL COVERAGE IN ALL PLANTING AREAS.
- CONTRACTOR TO WATER-IN ALL PLANTS ON THE SAME DAY THEY ARE INSTALLED. CONTRACTOR SHALL NOT INSTALL MORE PLANTS THAN CAN BE WATERED-IN ON THE SAME DAY.
- APPLY SHREDDED HARDWOOD MULCH TO A DEPTH OF 2 INCHES IN ALL TREE AND SHRUB PLANTING AREAS.
- LANDSCAPED AREAS SHALL BE KEPT FREE OF TRASH, LITTER, AND WEEDS AT ALL TIMES DURING CONSTRUCTION.
- REFERENCE PLANTING DETAILS & PLANT SCHEDULE. PLANT SPECIES AND LAYOUT PROVIDED BY THE LANDSCAPE ARCHITECT.
- ALL DISTURBED AREAS TO BE COVERED IN EROSION CONTROL MATTING OR BY OTHER APPROVED STABILIZATION MEASURES. SEE EROSION PROTECTION AND SEDIMENT CONTROL PLAN, NOTES AND DETAILS.
- SEE SHEET L305 AND L306 FOR TYPICAL PLANTING DETAILS.
- SEE SPECIFICATIONS FOR ADDITIONAL PLANTING REQUIREMENTS.

COUNTY OF	ITEM NO.	SHEET NO.
FRANKLIN	5-565	L-300

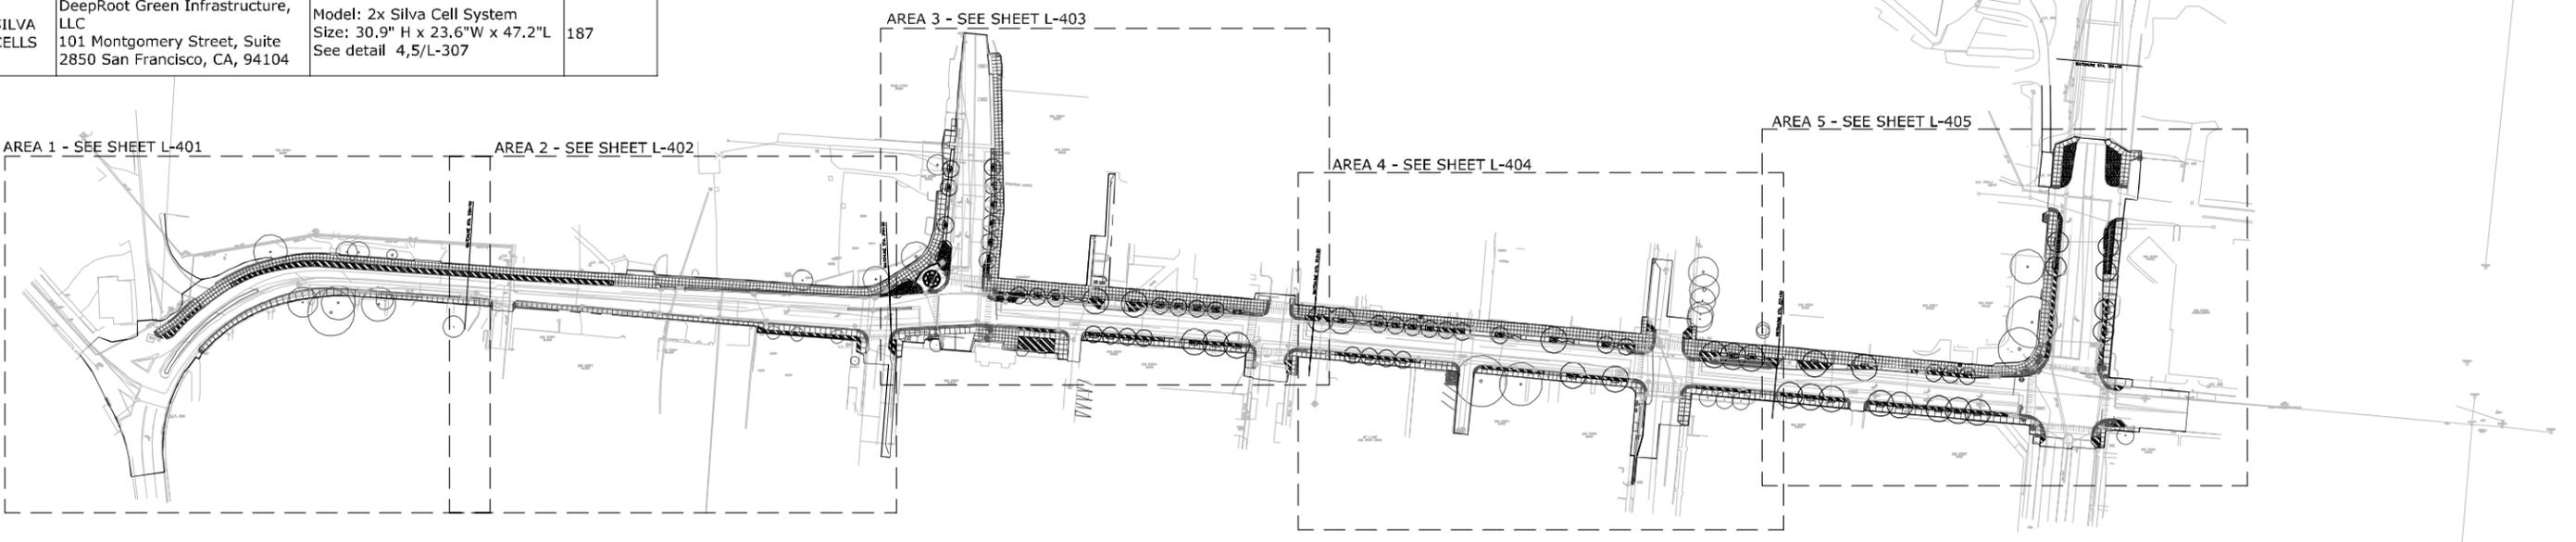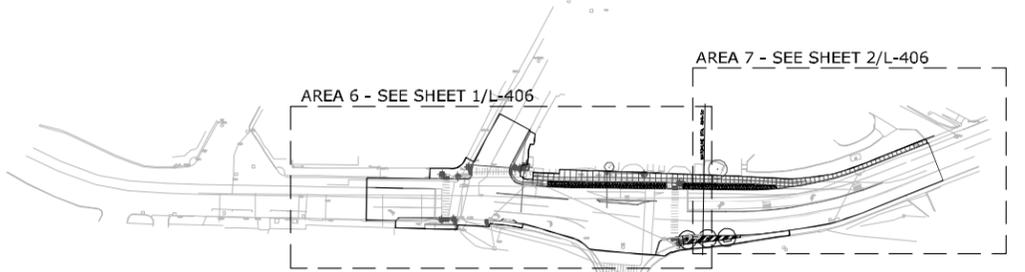

FRANKFORT SECOND STREET
OVERALL PLAN
PLANTING PLAN OVERVIEW

SCALE: 1"=100'

FILE NAME: X:\21900 PROJECTS\21906 (FRANKFORT 2ND STREET)\AUTOCAD\03_DD\L-300 PLANTING PLAN OVERVIEW.DWG

USER: kyan
DATE PLOTTED: March 11, 2020

E-SHEET NAME:

Power InRoads v8.11.7.443



COUNTY OF	ITEM NO.	SHEET NO.
FRANKLIN	5-565	L-301

FILE NAME: X:\21900 PROJECTS\21906 (FRANKFORT 2ND STREET)\AUTOCAD\03_DD\L-301 PLANTING PLAN - AREA 1.DWG

USER: kyon
DATE PLOTTED: March 11, 2020

E-SHEET NAME:

Power InRoads v8.11.7.443

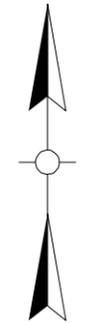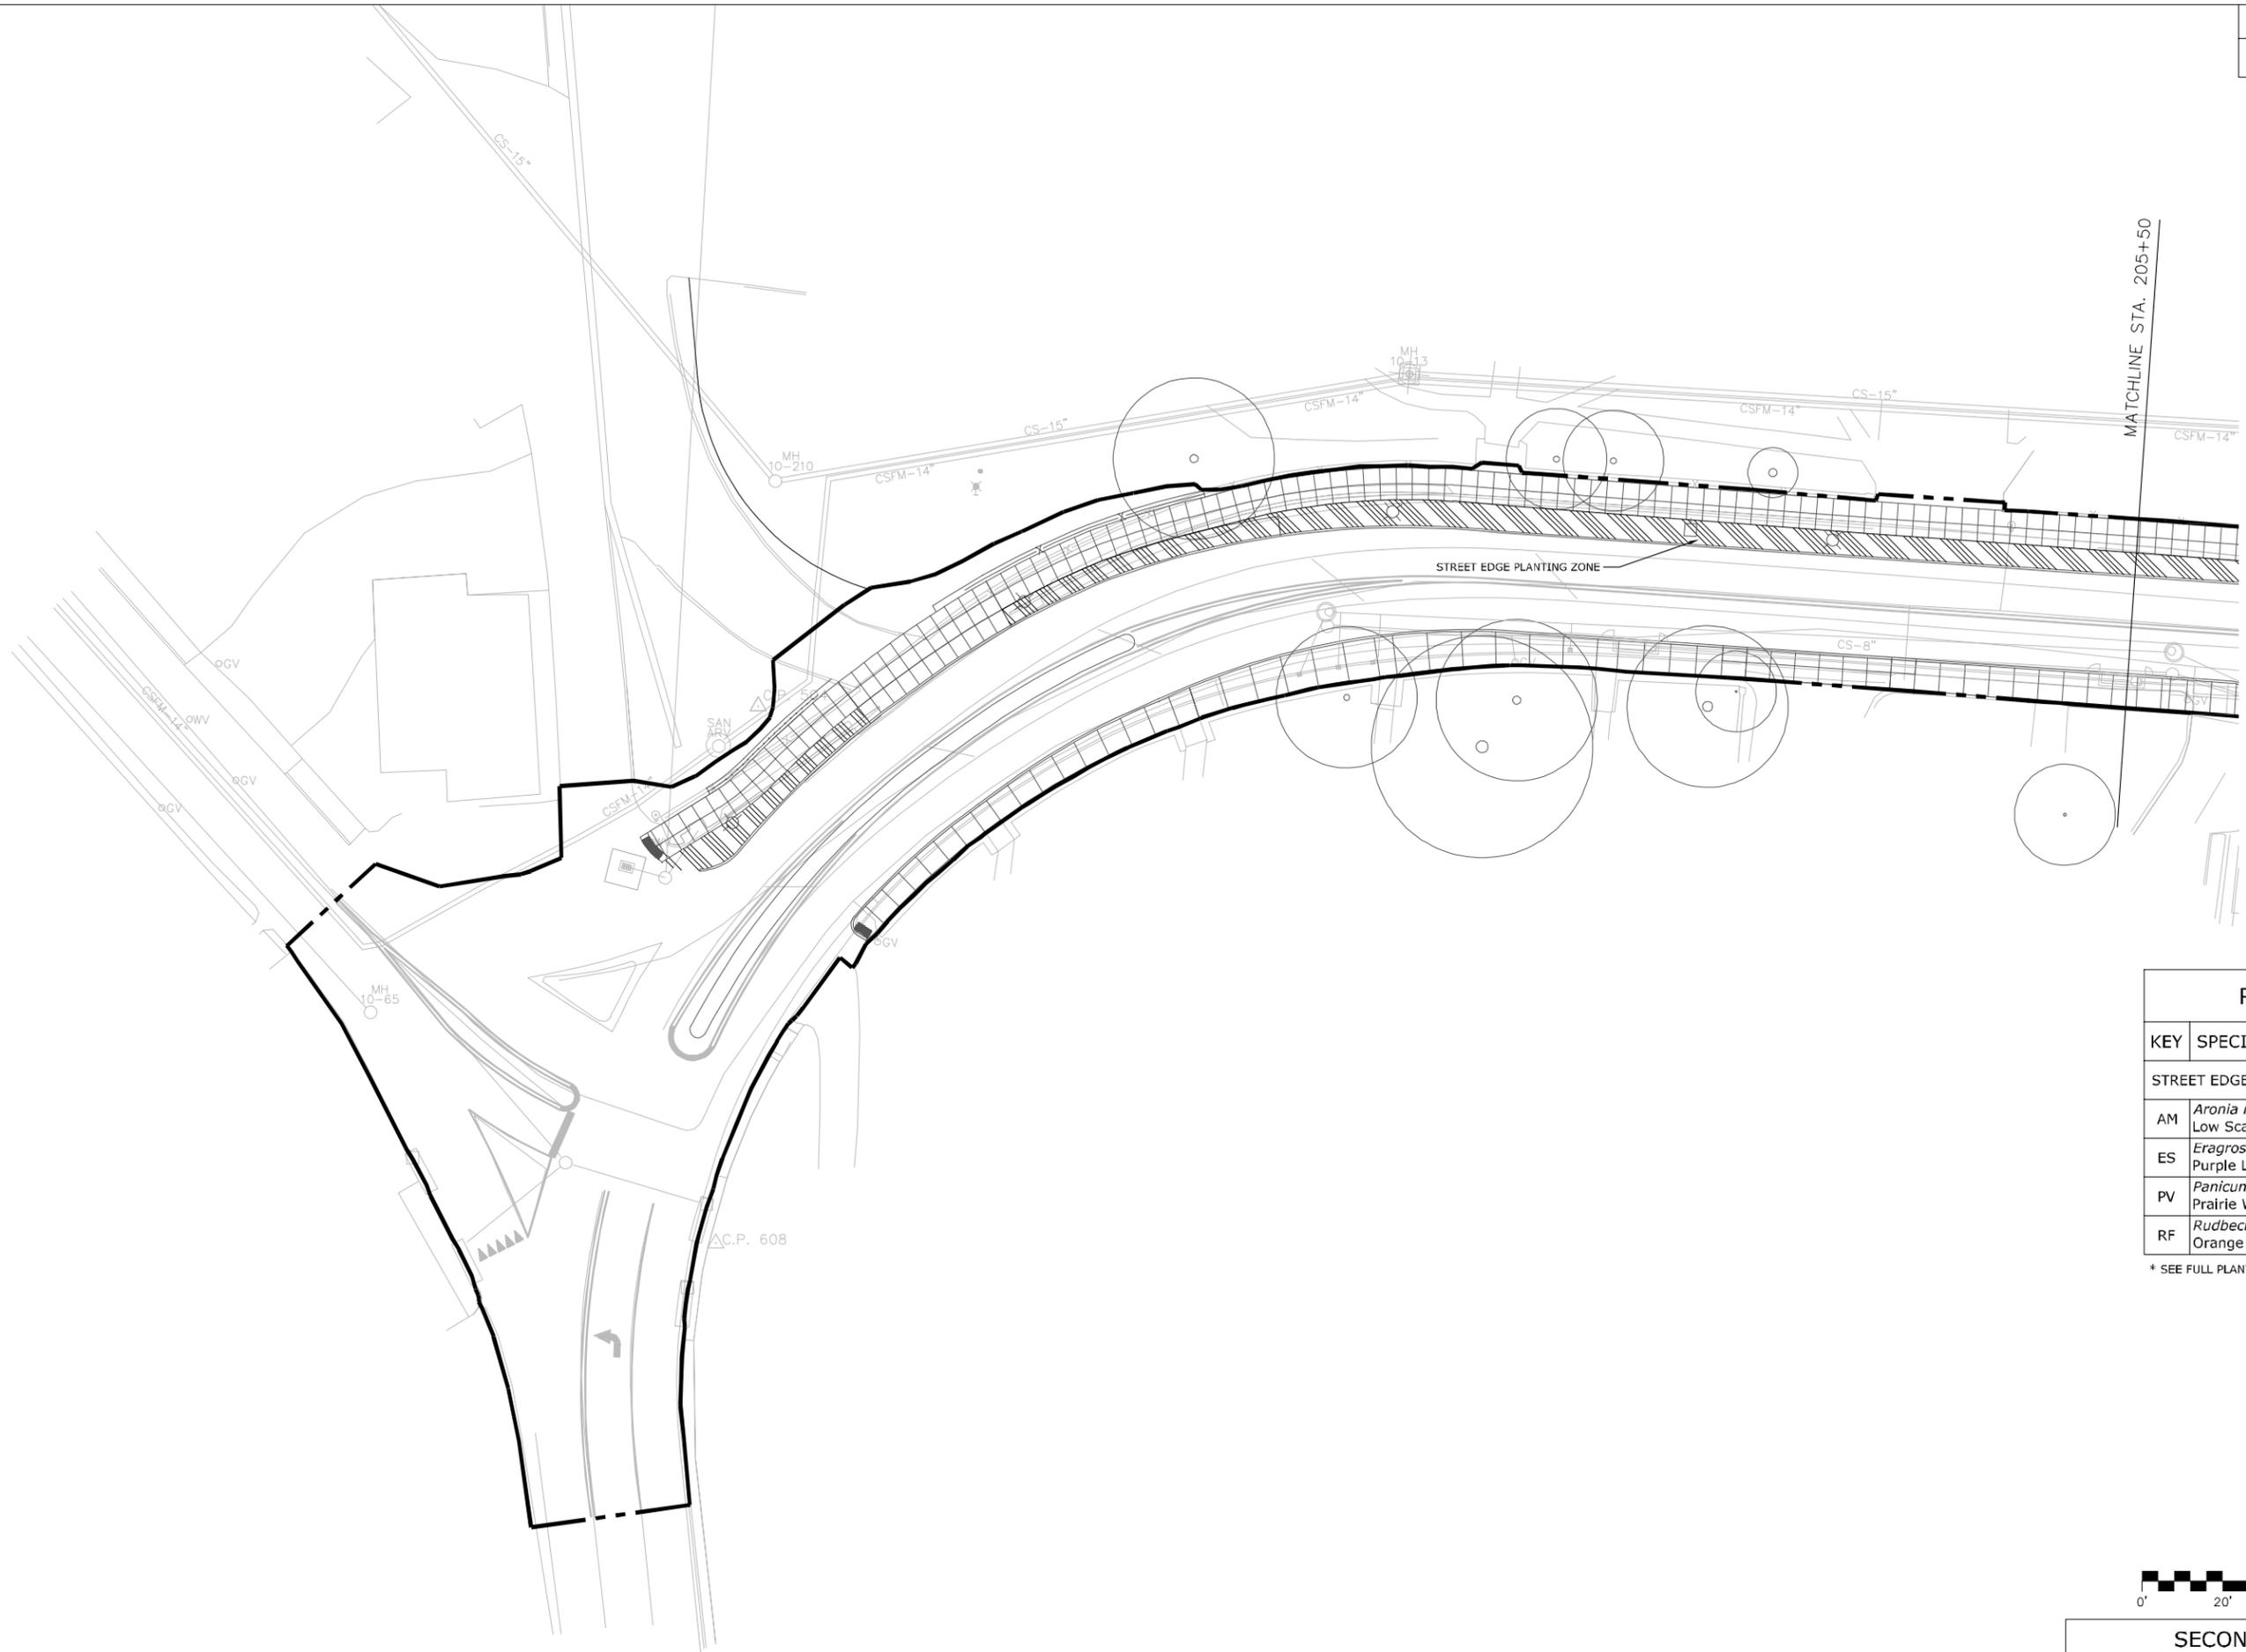

LEGEND	
KEY	VEGETATION TYPE
○	EXISTING TREE TO REMAIN
●	SHADE / ORNAMENTAL TREE
⊕ ⊕ ⊕	SHRUB / PERENNIAL
	GREEN INFRASTRUCTURE PLANTING ZONE
	GATEWAY PLANTING ZONE
	STREET EDGE PLANTING ZONE
	SILVA CELLS

PLANT SCHEDULE	
KEY	SPECIES
STREET EDGE LANDSCAPE SHRUBS & PERENNIALS	
AM	<i>Aronia melanocarpa</i> 'Low Scape Mound' Low Scape Mound Black Chokeberry
ES	<i>Eragrostis spectabilis</i> Purple Love Grass
PV	<i>Panicum virgatum</i> 'Prairie Winds Cheyenne Sky' Prairie Winds® 'Cheyenne Sky' Switch Grass
RF	<i>Rudbeckia fulgida</i> Orange Coneflower

* SEE FULL PLANT SCHEDULE ON SHEET L-400



SCALE: 1"=20'

SECOND STREET (US 60)
BEGINNING TO STA.205+50
PLANTING PLAN - AREA 1

FILE NAME: X:\21900 PROJECTS\21906 (FRANKFORT 2ND STREET)\AUTOCAD\03_DD\L-302 PLANTING PLAN - AREA 2.DWG


USER: kyan
DATE PLOTTED: March 11, 2020

E-SHEET NAME:

Power InRoads v8.11.7.443


COUNTY OF	ITEM NO.	SHEET NO.
FRANKLIN	5-565	L-302

LEGEND	
KEY	VEGETATION TYPE
	EXISTING TREE TO REMAIN
	SHADE / ORNAMENTAL TREE
	SHRUB / PERENNIAL / ORNAMENTAL GRASS
	GREEN INFRASTRUCTURE PLANTING ZONE
	GATEWAY PLANTING ZONE
	STREET EDGE PLANTING ZONE
	SILVA CELLS

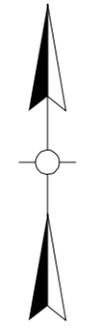

PLANT SCHEDULE	
KEY	SPECIES
STREET EDGE LANDSCAPE SHRUBS & PERENNIALS	
AM	<i>Aronia melanocarpa</i> 'Low Scape Mound' Low Scape Mound Black Chokeberry
ES	<i>Eragrostis spectabilis</i> Purple Love Grass
PV	<i>Panicum virgatum</i> 'Prairie Winds Cheyenne Sky' Prairie Winds® 'Cheyenne Sky' Switch Grass
RF	<i>Rudbeckia fulgida</i> Orange Coneflower


* SEE FULL PLANT SCHEDULE ON SHEET L-400

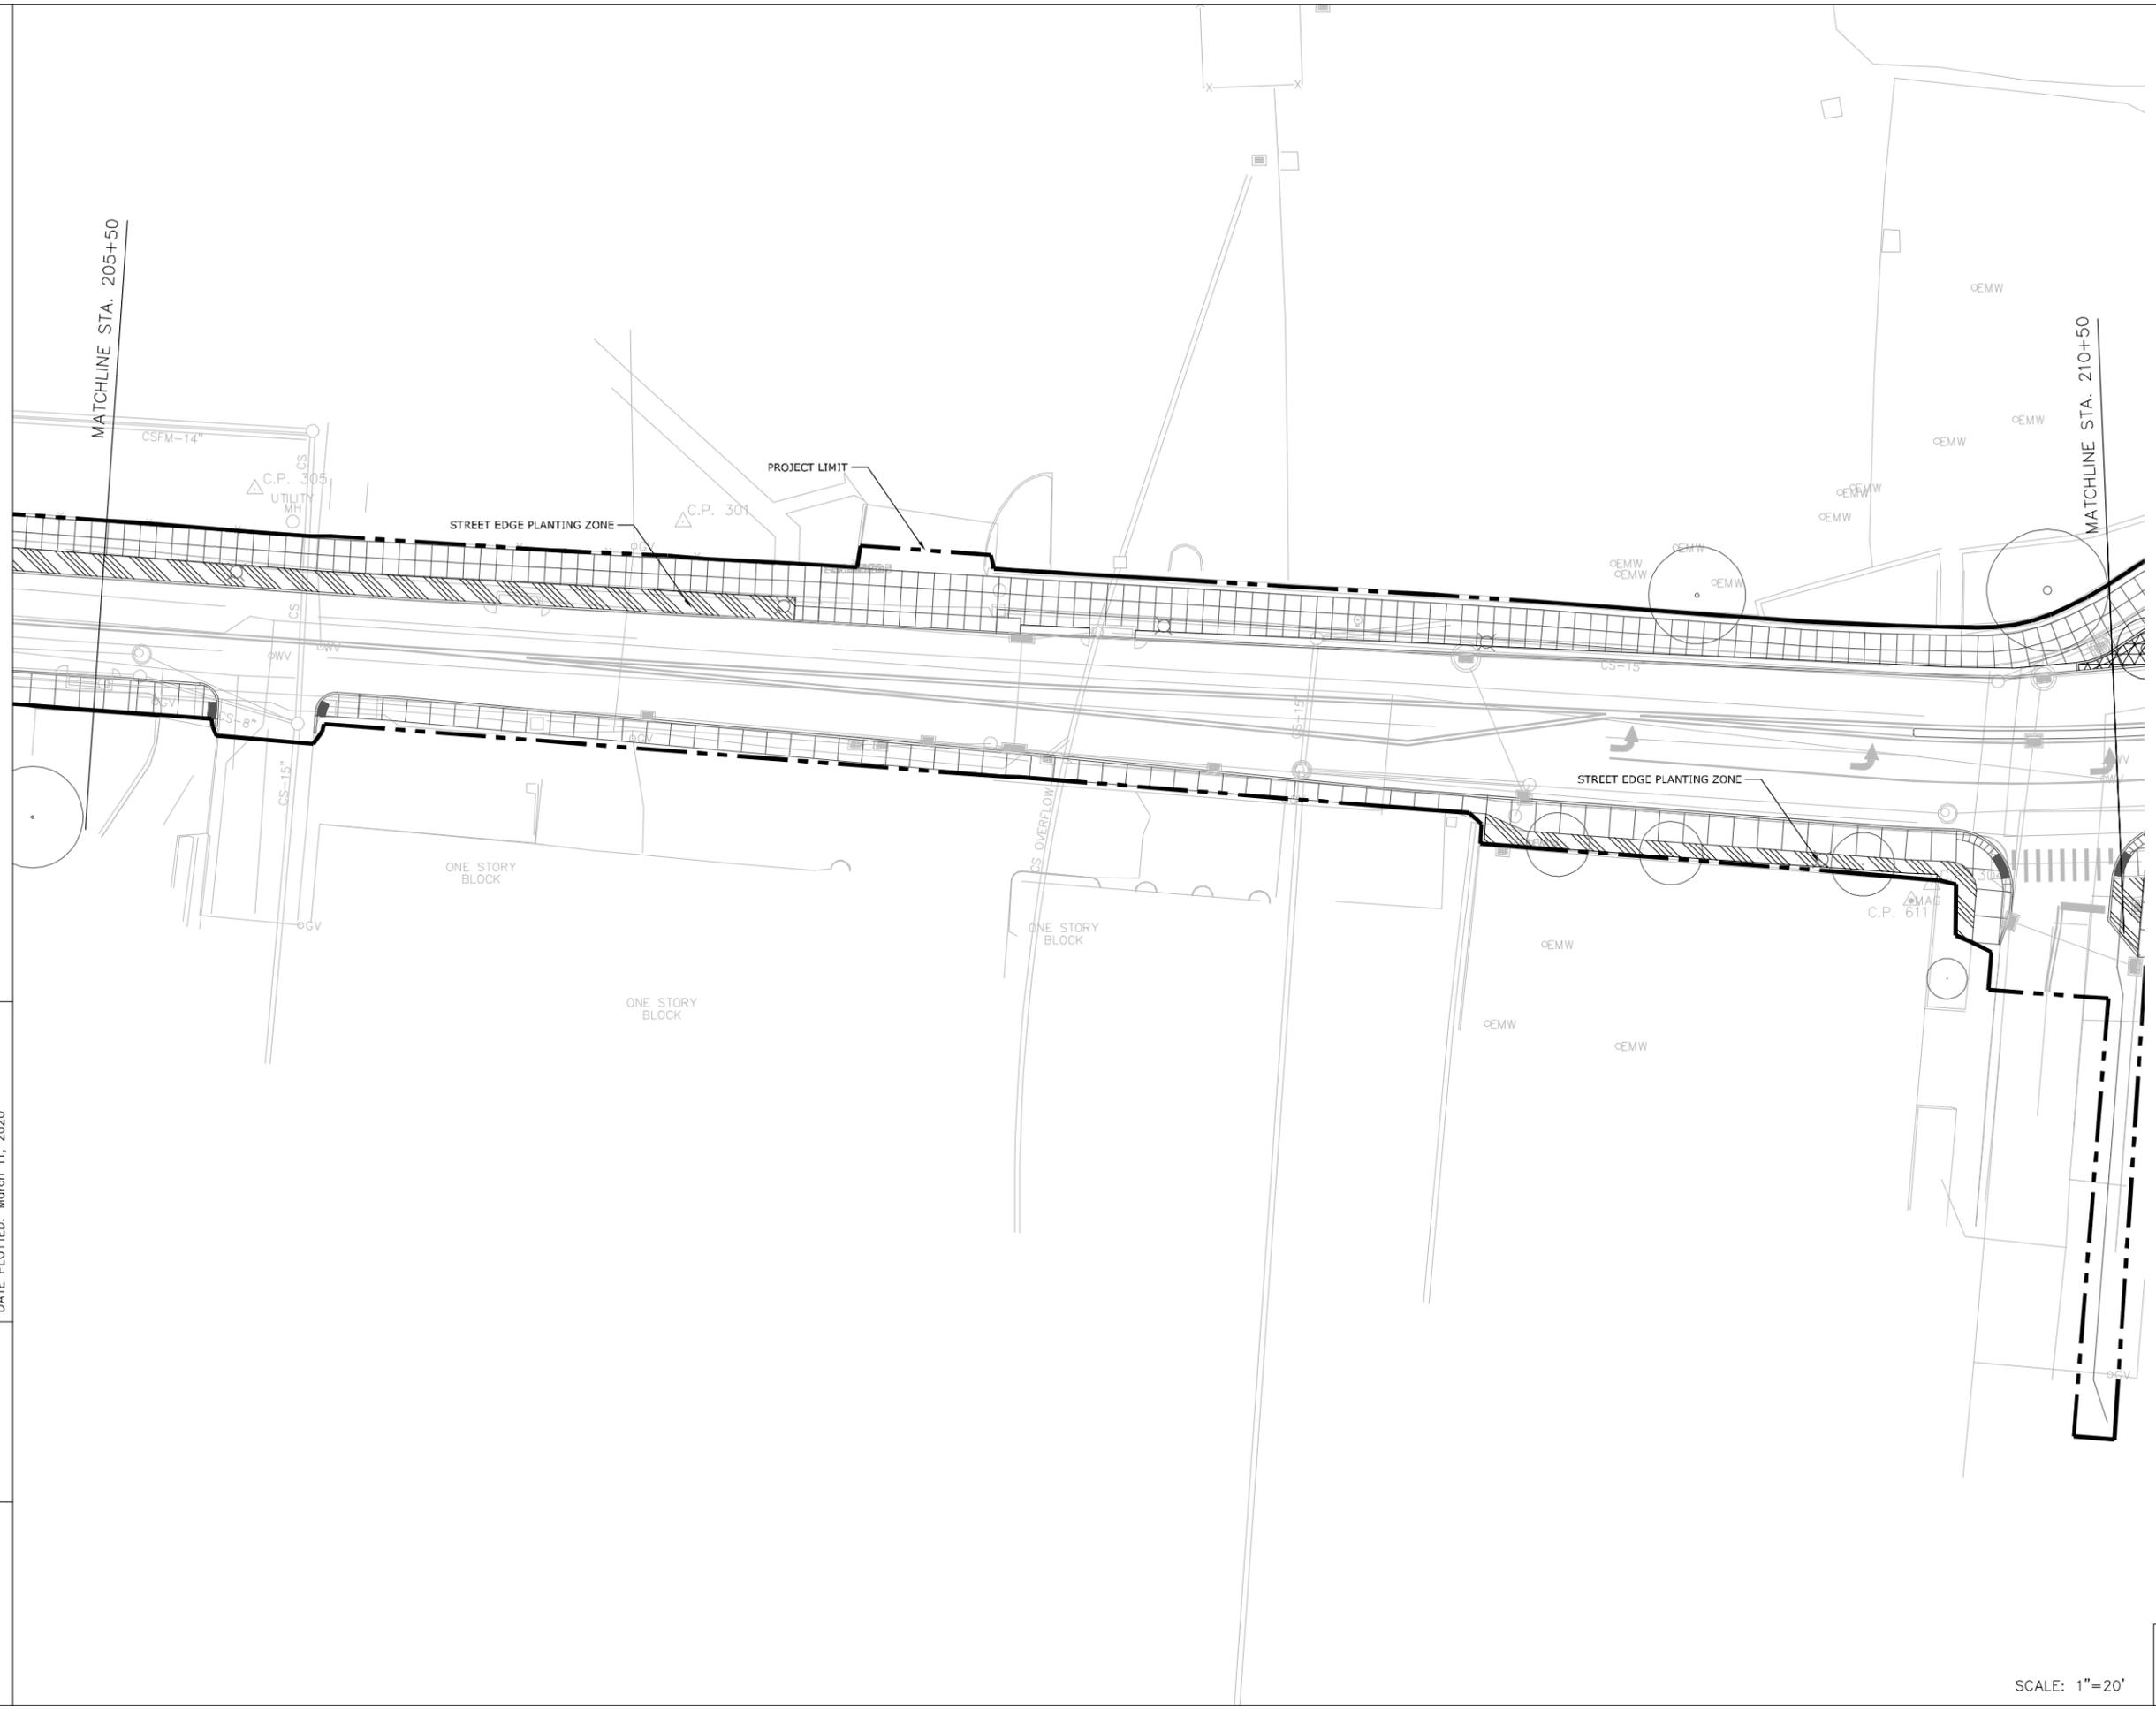

SCALE: 1"=20'

SECOND STREET (US 60)
STA. 205+50 TO STA. 210+50
PLANTING PLAN - AREA 2

LEGEND	
KEY	VEGETATION TYPE
○	EXISTING TREE TO REMAIN
◦	SHADE / ORNAMENTAL TREE
⊙	SHRUB / PERENNIAL
▨	GREEN INFRASTRUCTURE PLANTING ZONE
▩	GATEWAY PLANTING ZONE
▧	STREET EDGE PLANTING ZONE
⊠	SILVA CELLS

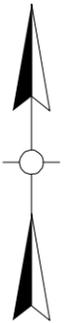


PLANT SCHEDULE	
KEY	SPECIES
TREES	
AL	<i>Amelanchier laevis</i> 'Cumulus' Cumulus Allegheny Serviceberry
GB	<i>Ginkgo biloba</i> 'Princeton Sentry' Princeton Sentry Ginkgo
TA	<i>Tilia americana</i> 'McKSentry' American Sentry Linden
QB	<i>Quercus bicolor</i> 'JFS-KW12' American Dream Swamp White Oak
GREEN INFRASTRUCTURE SHRUBS & PERENNIALS	
AM	<i>Aronia melanocarpa</i> 'Low Scape Mound' Low Scape Mound Black Chokeberry
CO	<i>Coreopsis verticillata</i> 'Zagreb' Zagreb Threadleaf Tickseed
PV	<i>Panicum virgatum</i> 'Prairie Winds Cheyenne Sky' Prairie Winds® 'Cheyenne Sky' Switch Grass
SO	<i>Symphoricarpos orbiculatus</i> 'Proud Berry' Proud Berry Coral Berry
STREET EDGE LANDSCAPE SHRUBS & PERENNIALS	
AM	<i>Aronia melanocarpa</i> 'Low Scape Mound' Low Scape Mound Black Chokeberry
ES	<i>Eragrostis spectabilis</i> Purple Love Grass
PV	<i>Panicum virgatum</i> 'Prairie Winds Cheyenne Sky' Prairie Winds® 'Cheyenne Sky' Switch Grass
RF	<i>Rudbeckia fulgida</i> Orange Coneflower
GATEWAY LANDSCAPE SHRUBS & PERENNIALS	
AM	<i>Aronia melanocarpa</i> 'Low Scape Mound' Low Scape Mound Black Chokeberry
CA	<i>Ceanothus americanus</i> New Jersey Tea
CO	<i>Coreopsis verticillata</i> 'Zagreb' Zagreb Threadleaf Tickseed
ES	<i>Eragrostis spectabilis</i> Purple Love Grass
RF	<i>Rudbeckia fulgida</i> Orange Coneflower
SS	<i>Schizachyrium scoparium</i> 'The Blues' The Blues Little Bluestem


* SEE FULL PLANT SCHEDULE ON SHEET L-400



2 GREEN INFRASTRUCTURE PLANTING ENLARGEMENT
SCALE: 1" = 5'-0"

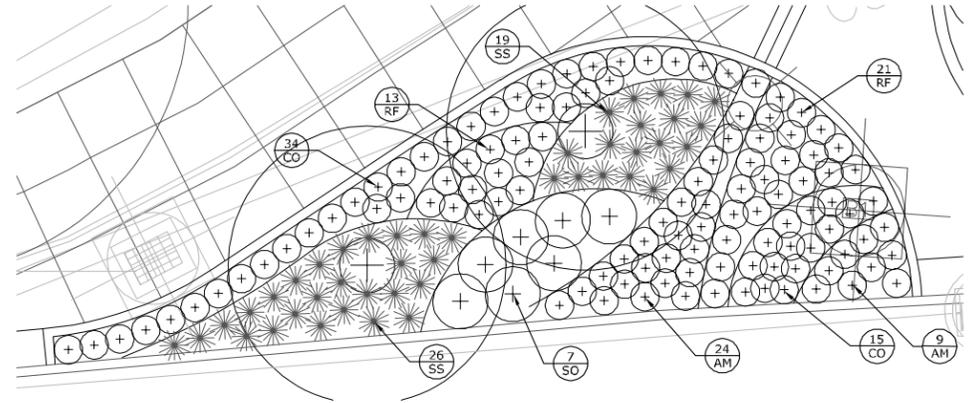

3 GATEWAY PLANTING ENLARGEMENT
SCALE: 1" = 5'-0"

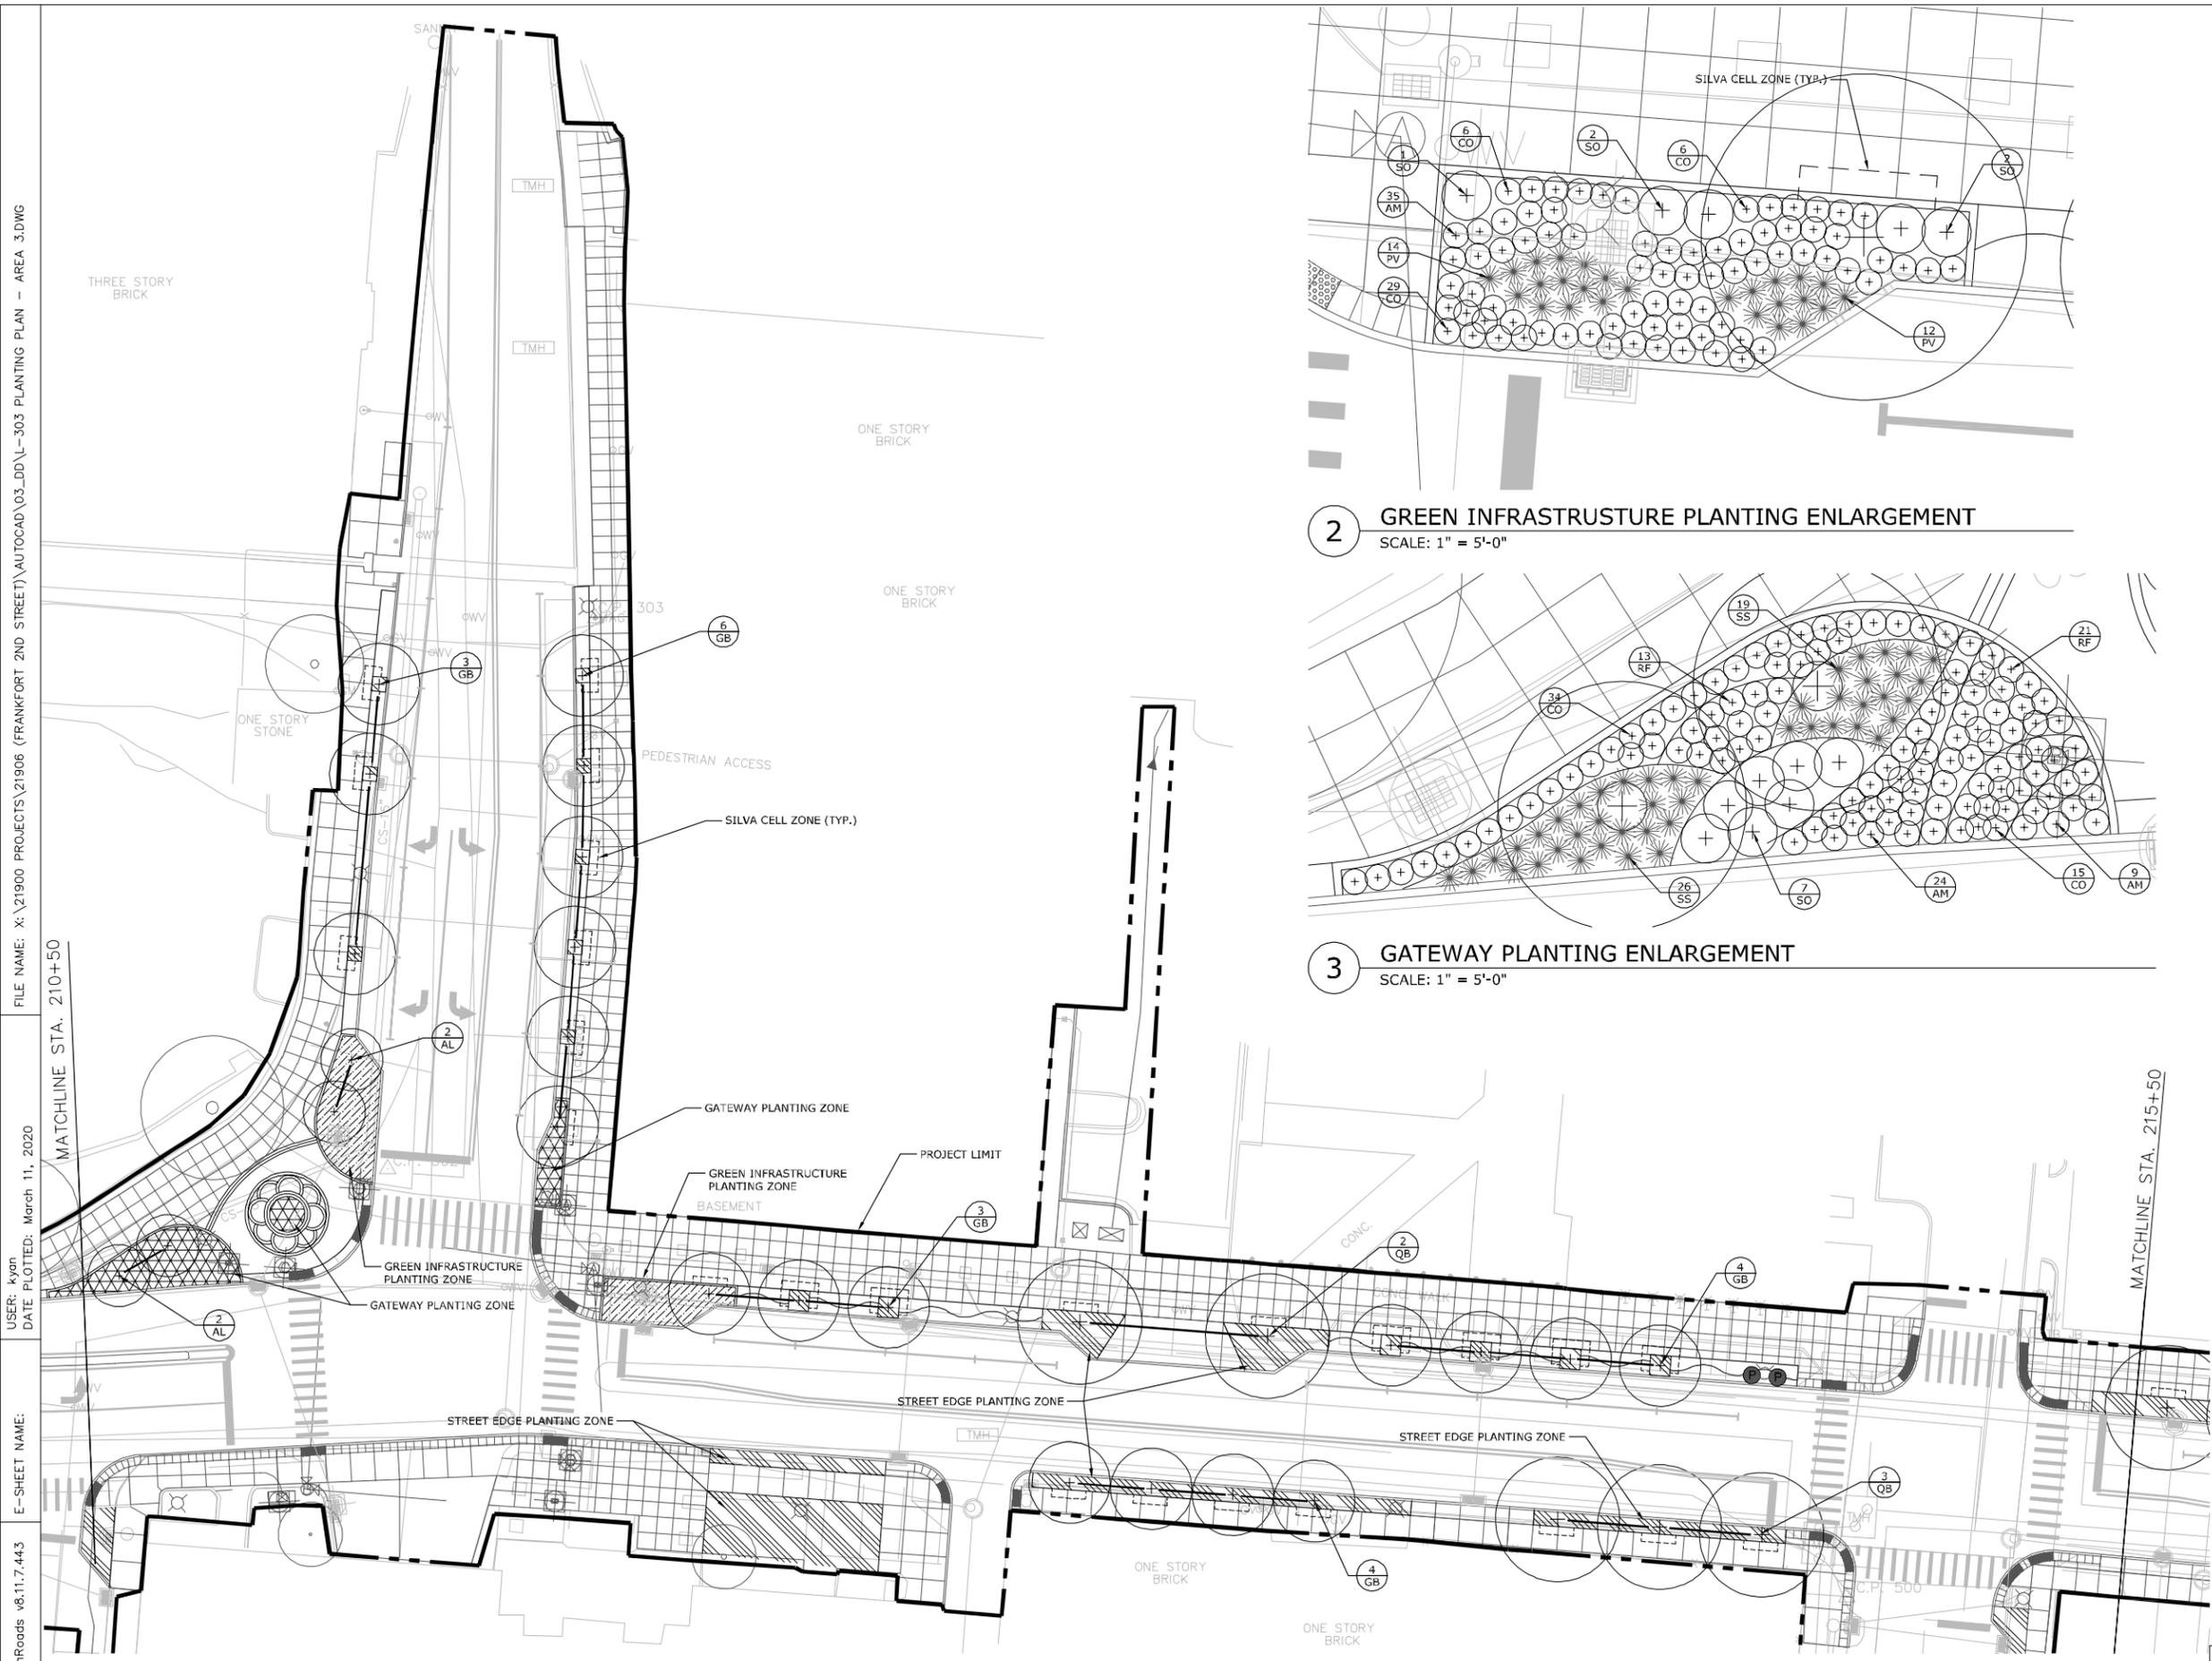

1 2ND STREET (STA. 210+50 TO 215+50)
SCALE: 1" = 20'-0"

SECOND STREET (US 60) STA. 210+50 TO STA. 215+50 & BRIDGE STREET PLANTING PLAN - AREA 3

FILE NAME: X:\21900 PROJECTS\21906 (FRANKFORT 2ND STREET)\AUTOCAD\03_DD\L-303 PLANTING PLAN - AREA 3.DWG
 USER: kyon
 DATE PLOTTED: March 11, 2020
 E-SHEET NAME:
 Power InRoads v8.11.7.443


FILE NAME: X:\21900 PROJECTS\21906 (FRANKFORT 2ND STREET)\AUTOCAD\03_DD\L-304 PLANTING PLAN - AREA 4.DWG
 USER: kyan
 DATE PLOTTED: March 11, 2020
 E-SHEET NAME:
 Power InRoads v8.11.7.443

PLANT SCHEDULE


KEY	SPECIES
TREES	
AL	<i>Amelanchier laevis</i> 'Cumulus' Cumulus Allegheny Serviceberry
GB	<i>Ginkgo biloba</i> 'Princeton Sentry' Princeton Sentry Ginkgo
TA	<i>Tilia americana</i> 'McKSentry' American Sentry Linden
QB	<i>Quercus bicolor</i> 'JFS-KW12' American Dream Swamp White Oak
STREET EDGE LANDSCAPE SHRUBS & PERENNIALS	
AM	<i>Aronia melanocarpa</i> 'Low Scape Mound' Low Scape Mound Black Chokeberry
ES	<i>Eragrostis spectabilis</i> Purple Love Grass
PV	<i>Panicum virgatum</i> 'Prairie Winds Cheyenne Sky' Prairie Winds® 'Cheyenne Sky' Switch Grass
RF	<i>Rudbeckia fulgida</i> Orange Coneflower

* SEE FULL PLANT SCHEDULE ON SHEET L-400

COUNTY OF	ITEM NO.	SHEET NO.
FRANKLIN	5-565	L-304

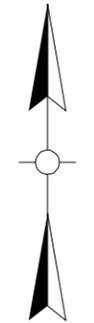


LEGEND	
KEY	VEGETATION TYPE
○	EXISTING TREE TO REMAIN
◉	SHADE / ORNAMENTAL TREE
⊙	SHRUB / PERENNIAL
▨	GREEN INFRASTRUCTURE PLANTING ZONE
▩	GATEWAY PLANTING ZONE
▧	STREET EDGE PLANTING ZONE
⊠	SILVA CELLS

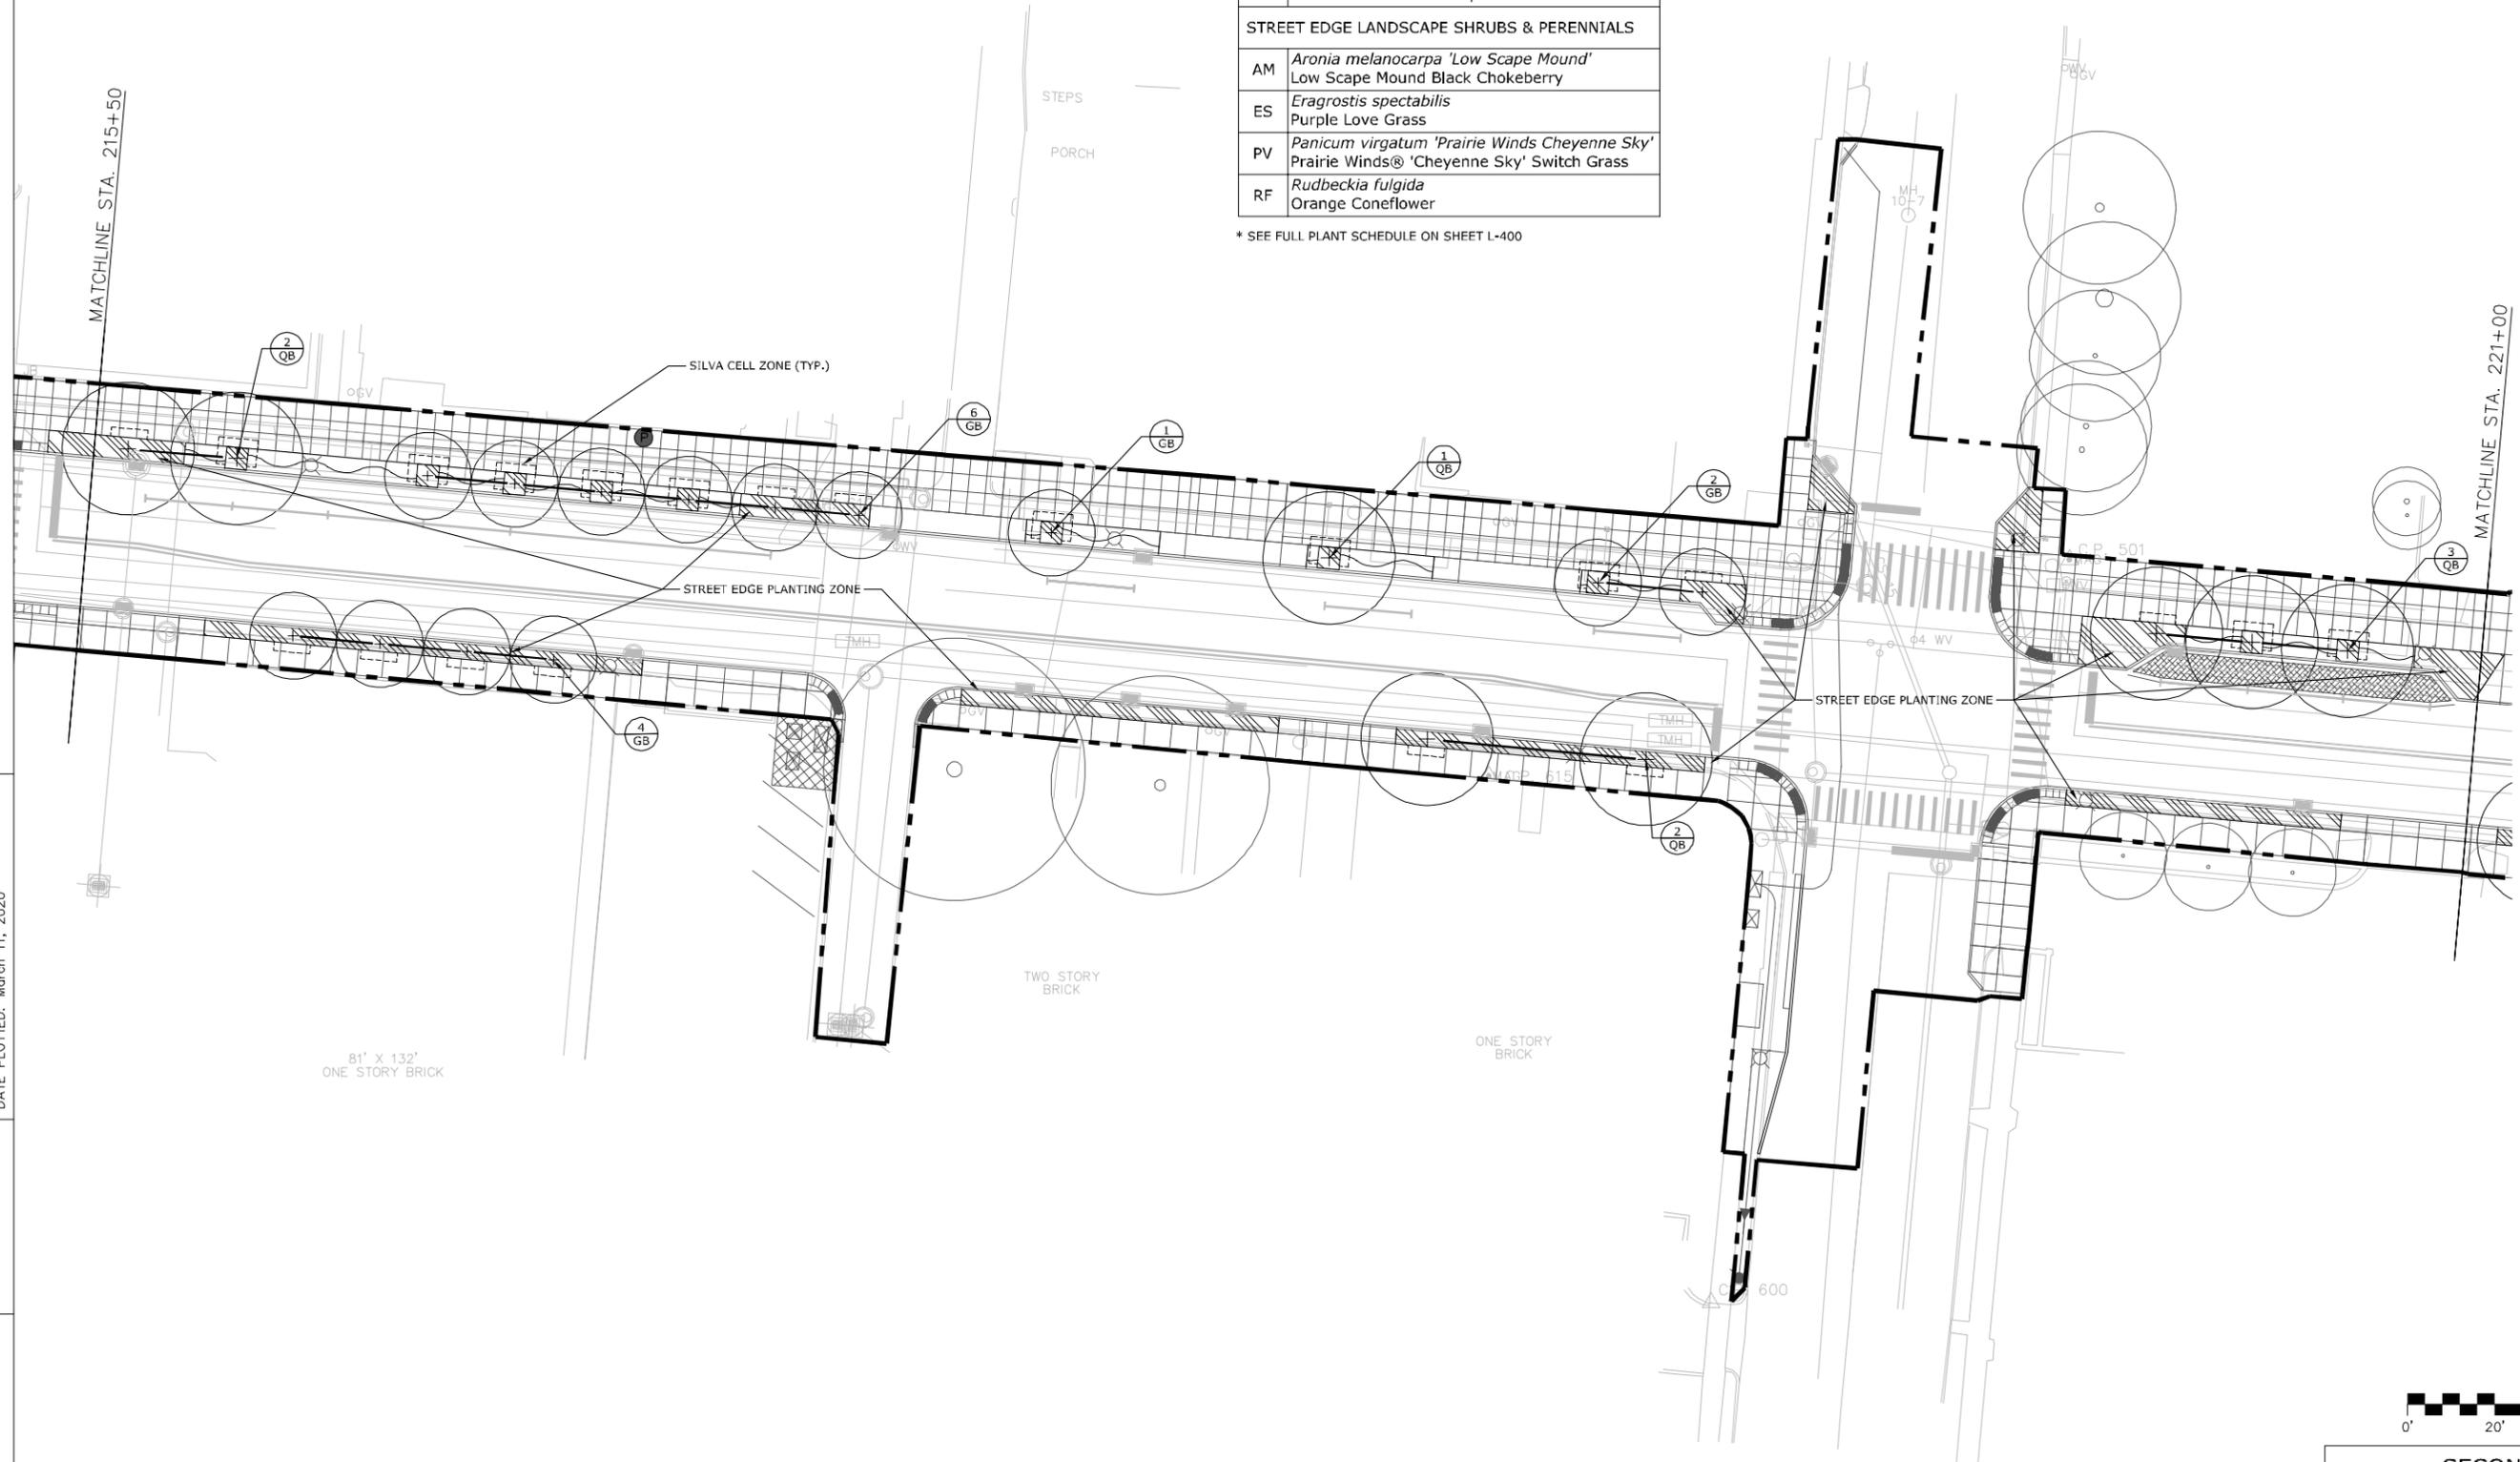

SCALE: 1"=20'

SECOND STREET (US 60)
 STA. 215+50 TO STA. 221+00
 PLANTING PLAN - AREA 4

LEGEND	
KEY	VEGETATION TYPE
○	EXISTING TREE TO REMAIN
◉	SHADE / ORNAMENTAL TREE
⊙	SHRUB / PERENNIAL
▨	GREEN INFRASTRUCTURE PLANTING ZONE
▩	GATEWAY PLANTING ZONE
▧	STREET EDGE PLANTING ZONE
⊠	SILVA CELLS

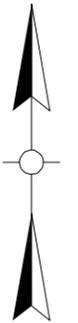


PLANT SCHEDULE	
KEY	SPECIES
TREES	
AL	<i>Amelanchier laevis</i> 'Cumulus' Cumulus Allegheny Serviceberry
GB	<i>Ginkgo biloba</i> 'Princeton Sentry' Princeton Sentry Ginkgo
TA	<i>Tilia americana</i> 'McKSentry' American Sentry Linden
QB	<i>Quercus bicolor</i> 'JFS-KW12' American Dream Swamp White Oak
GREEN INFRASTRUCTURE SHRUBS & PERENNIALS	
AM	<i>Aronia melanocarpa</i> 'Low Scape Mound' Low Scape Mound Black Chokeberry
CO	<i>Coreopsis verticillata</i> 'Zagreb' Zagreb Threadleaf Tickseed
PV	<i>Panicum virgatum</i> 'Prairie Winds Cheyenne Sky' Prairie Winds® 'Cheyenne Sky' Switch Grass
SO	<i>Symphoricarpos orbiculatus</i> 'Proud Berry' Proud Berry Coral Berry
STREET EDGE LANDSCAPE SHRUBS & PERENNIALS	
AM	<i>Aronia melanocarpa</i> 'Low Scape Mound' Low Scape Mound Black Chokeberry
ES	<i>Eragrostis spectabilis</i> Purple Love Grass
PV	<i>Panicum virgatum</i> 'Prairie Winds Cheyenne Sky' Prairie Winds® 'Cheyenne Sky' Switch Grass
RF	<i>Rudbeckia fulgida</i> Orange Coneflower
GATEWAY LANDSCAPE SHRUBS & PERENNIALS	
AM	<i>Aronia melanocarpa</i> 'Low Scape Mound' Low Scape Mound Black Chokeberry
CA	<i>Ceanothus americanus</i> New Jersey Tea
CO	<i>Coreopsis verticillata</i> 'Zagreb' Zagreb Threadleaf Tickseed
ES	<i>Eragrostis spectabilis</i> Purple Love Grass
RF	<i>Rudbeckia fulgida</i> Orange Coneflower
SS	<i>Schizachyrium scoparium</i> 'The Blues' The Blues Little Bluestem

* SEE FULL PLANT SCHEDULE ON SHEET L-400



SECOND STREET (US 60)
STA. 221+00 TO END & CAPITAL AVE
PLANTING PLAN - AREA 5


FILE NAME: X:\21900 PROJECTS\21906 (FRANKFORT 2ND STREET)\AUTOCAD\03_DD\L-305 PLANTING PLAN - AREA 5.DWG
 USER: kyon
 DATE PLOTTED: March 11, 2020
 E-SHEET NAME:
 Power InRoads v8.11.7.443

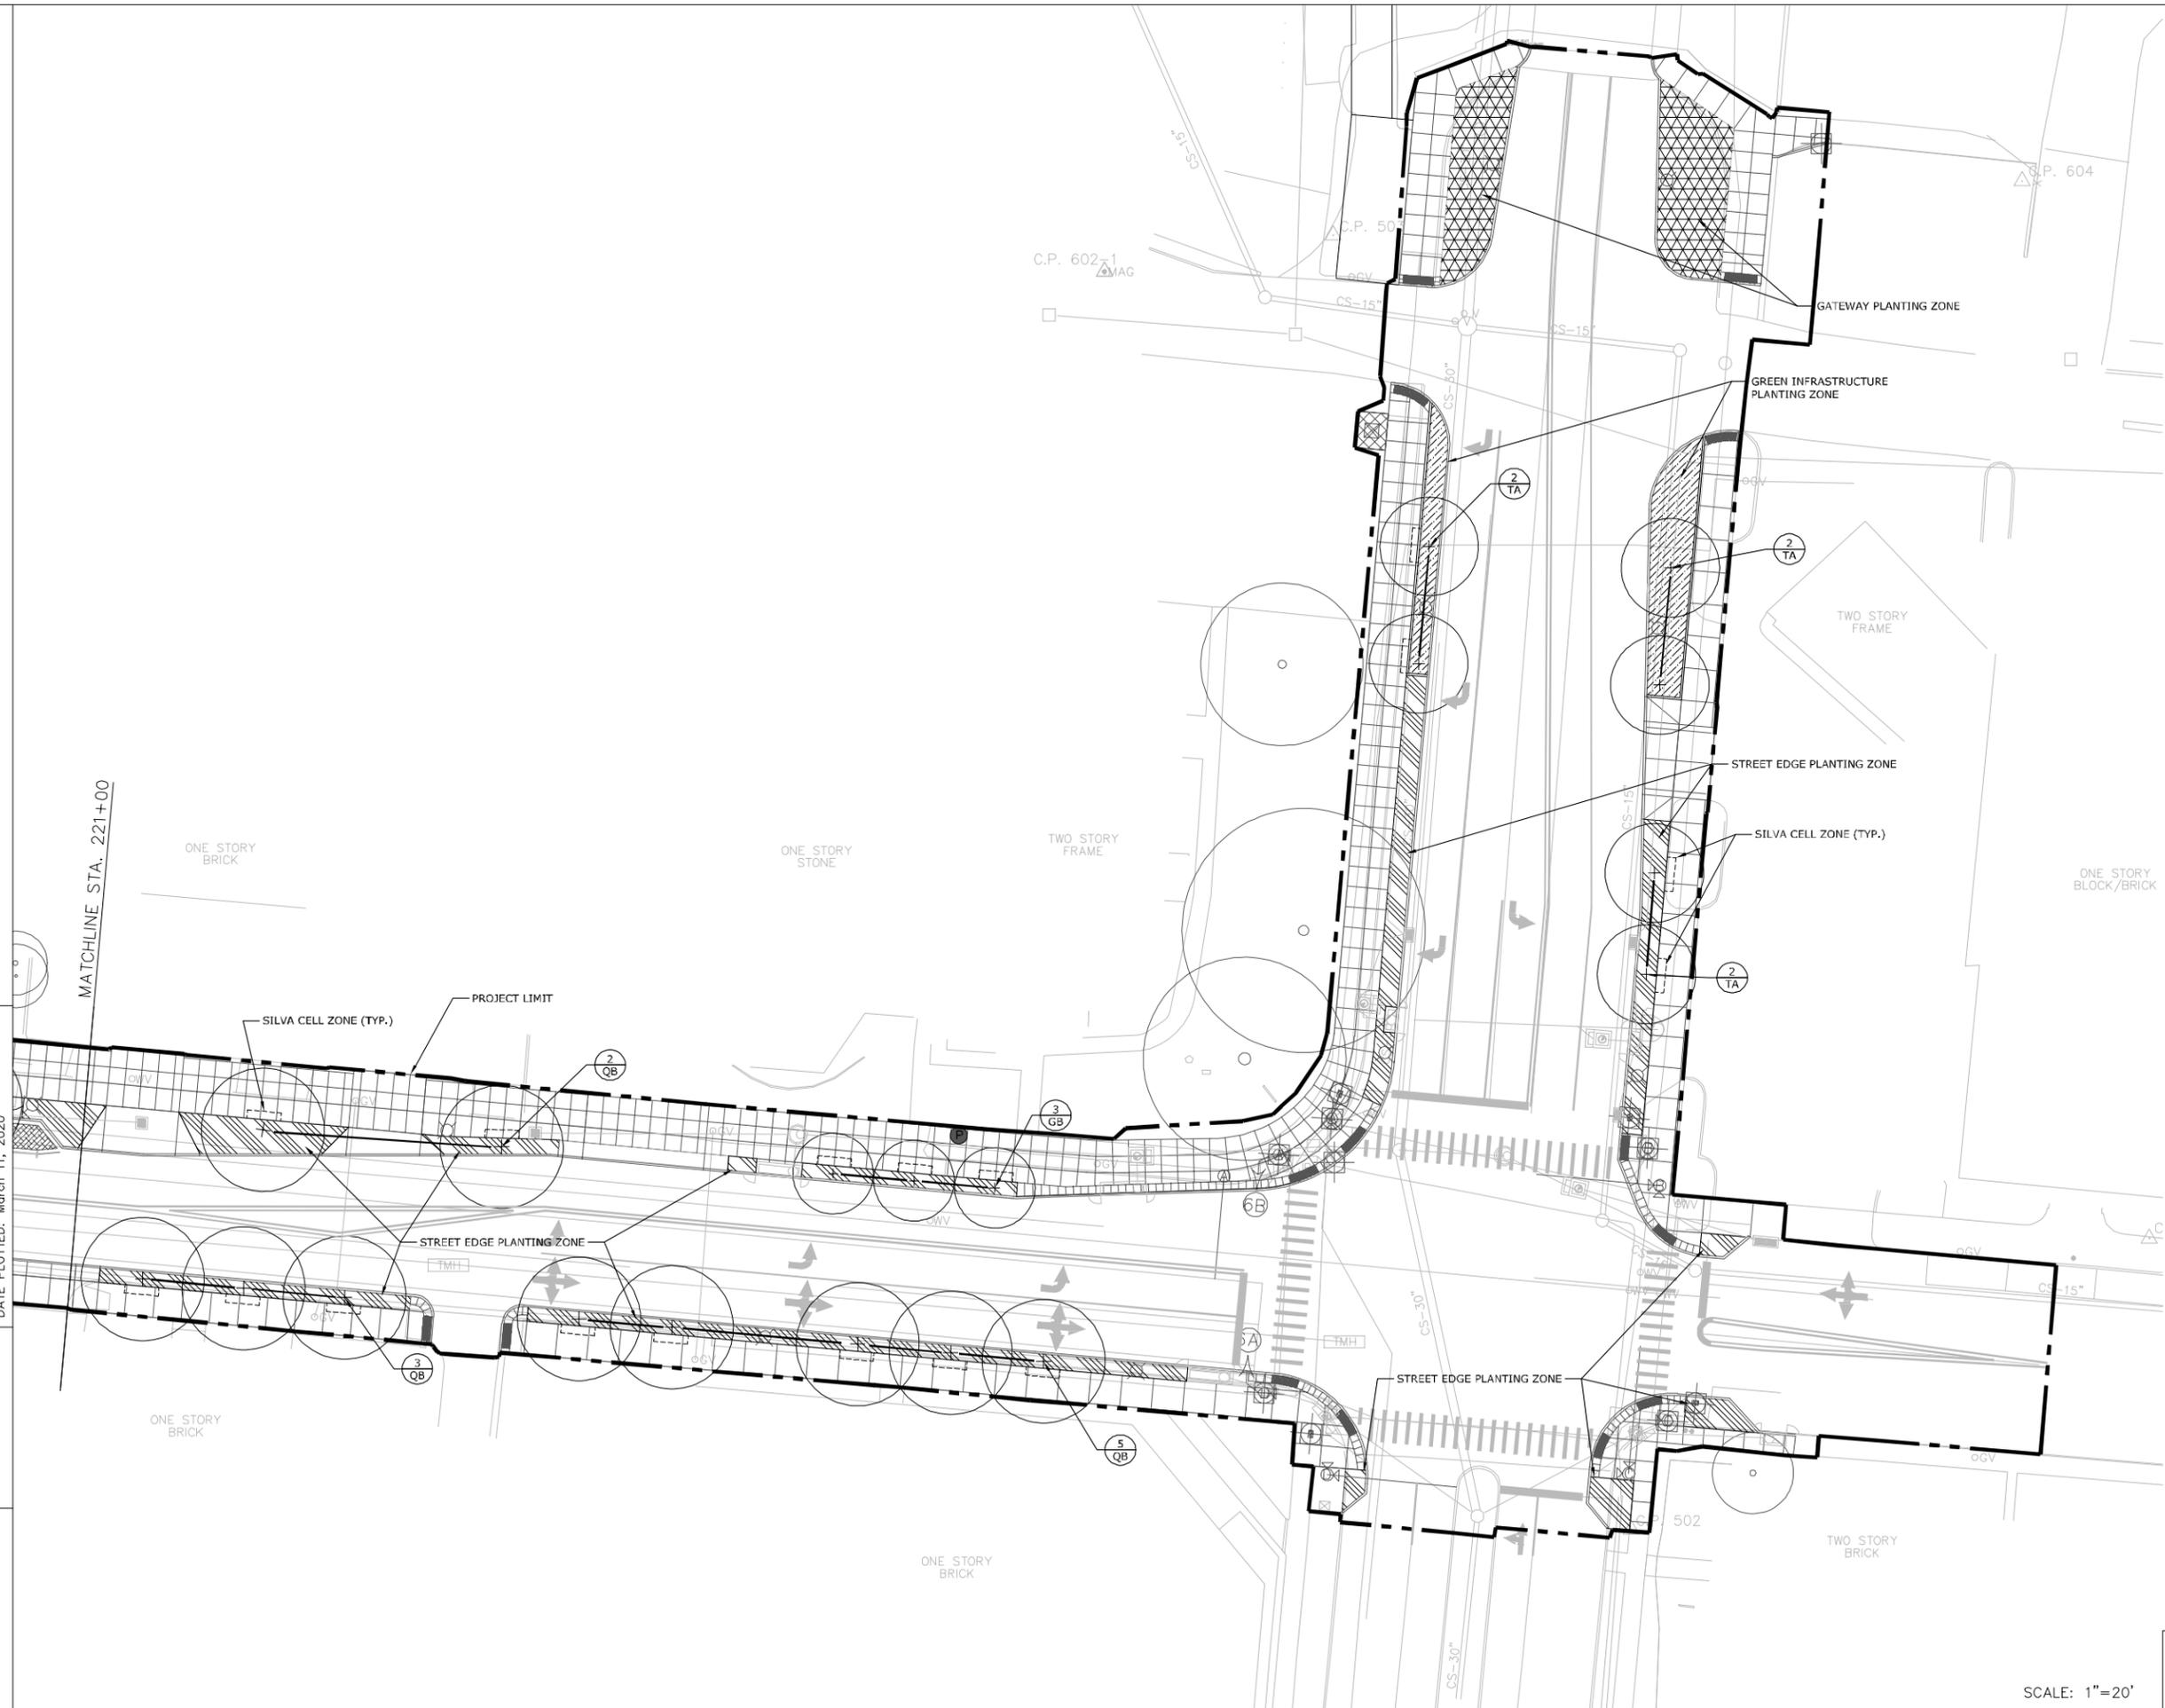

SCALE: 1"=20'


COUNTY OF	ITEM NO.	SHEET NO.
FRANKLIN	5-565	L-306

LEGEND	
KEY	VEGETATION TYPE
○	EXISTING TREE TO REMAIN
⊙	SHADE / ORNAMENTAL TREE
⊙⊙⊙	SHRUB / PERENNIAL
▨	GREEN INFRASTRUCTURE PLANTING ZONE
▩	GATEWAY PLANTING ZONE
▧	STREET EDGE PLANTING ZONE
□	SILVA CELLS

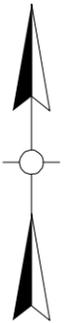


PLANT SCHEDULE	
KEY	SPECIES
TREES	
AL	<i>Amelanchier laevis</i> 'Cumulus' Cumulus Allegheny Serviceberry
GB	<i>Ginkgo biloba</i> 'Princeton Sentry' Princeton Sentry Ginkgo
TA	<i>Tilia americana</i> 'McKSentry' American Sentry Linden
QB	<i>Quercus bicolor</i> 'JFS-KW12' American Dream Swamp White Oak
STREET EDGE LANDSCAPE SHRUBS & PERENNIALS	
AM	<i>Aronia melanocarpa</i> 'Low Scape Mound' Low Scape Mound Black Chokeberry
ES	<i>Eragrostis spectabilis</i> Purple Love Grass
PV	<i>Panicum virgatum</i> 'Prairie Winds Cheyenne Sky' Prairie Winds® 'Cheyenne Sky' Switch Grass
RF	<i>Rudbeckia fulgida</i> Orange Coneflower
GATEWAY LANDSCAPE SHRUBS & PERENNIALS	
AM	<i>Aronia melanocarpa</i> 'Low Scape Mound' Low Scape Mound Black Chokeberry
CA	<i>Ceanothus americanus</i> New Jersey Tea
CO	<i>Coreopsis verticillata</i> 'Zagreb' Zagreb Threadleaf Tickseed
ES	<i>Eragrostis spectabilis</i> Purple Love Grass
RF	<i>Rudbeckia fulgida</i> Orange Coneflower
SS	<i>Schizachyrium scoparium</i> 'The Blues' The Blues Little Bluestem


* SEE FULL PLANT SCHEDULE ON SHEET L-400

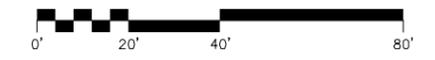

FILE NAME: X:\21900 PROJECTS\21906 (FRANKFORT 2ND STREET)\AUTOCAD\03_DD\L-306 PLANTING PLAN - AREA 6 & 7.DWG
 USER: kyon
 DATE PLOTTED: March 11, 2020
 E-SHEET NAME:
 Power InRoads v8.11.7.443

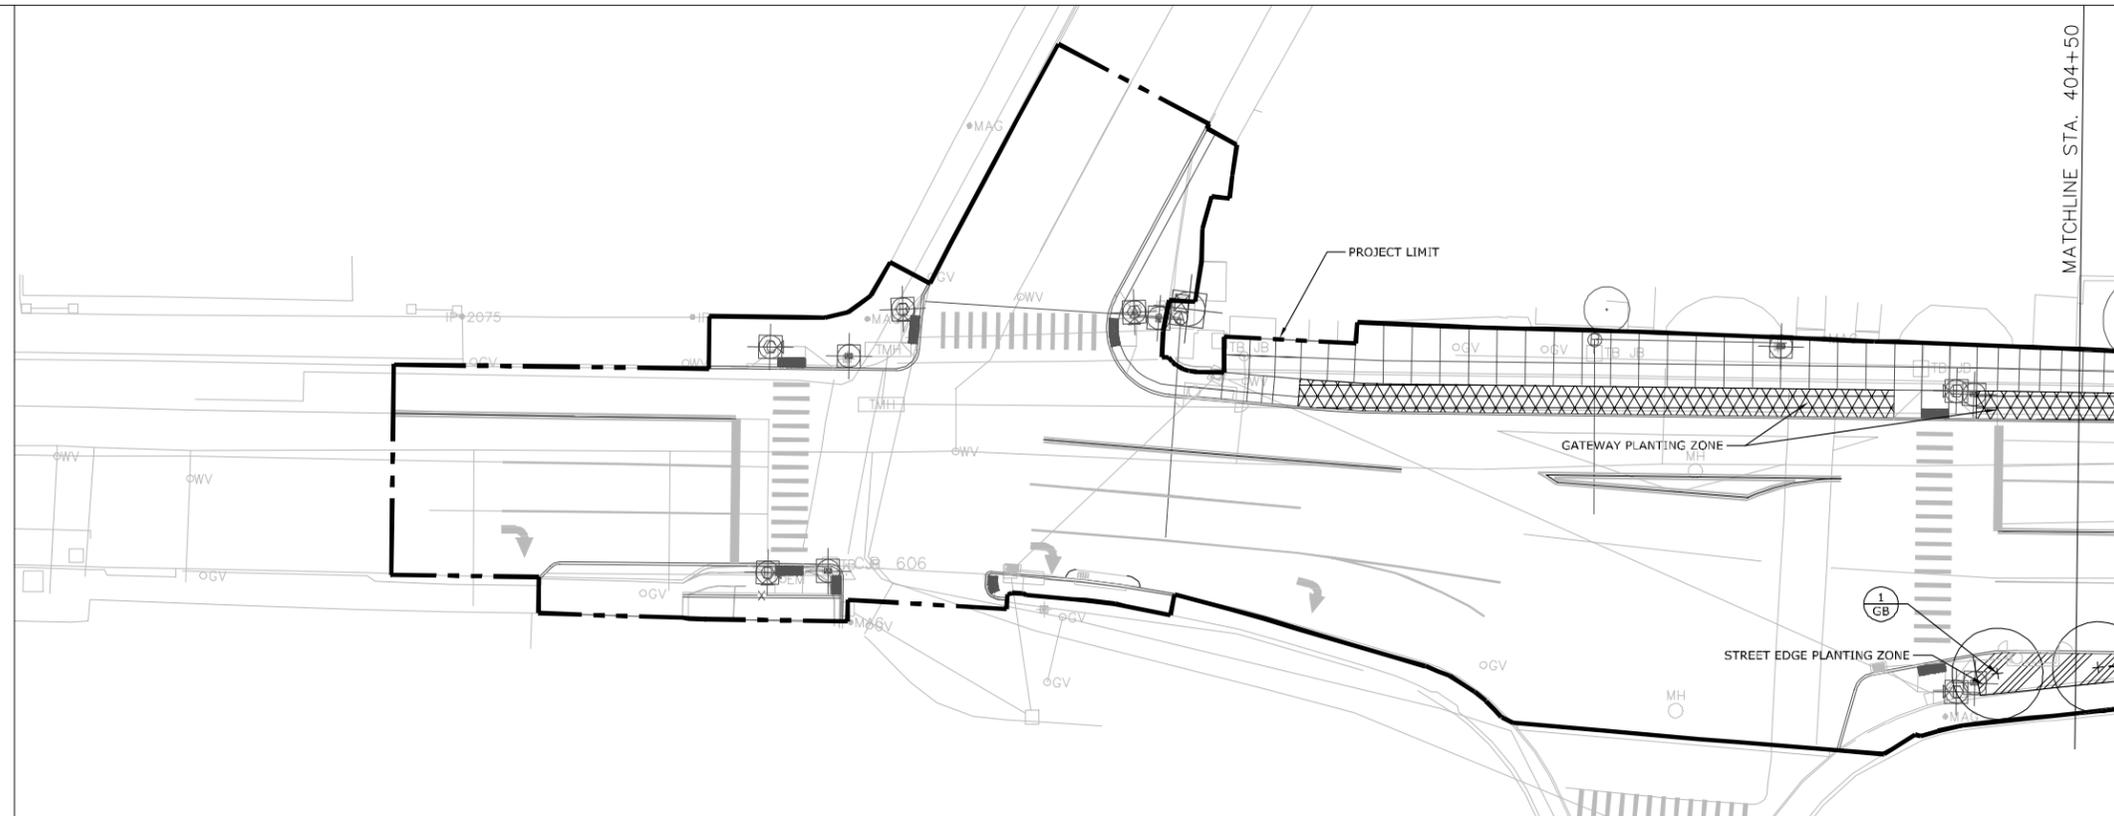



1 MAIN STREET (BEGINNING TO STA. 404+50)
SCALE: 1" = 20'

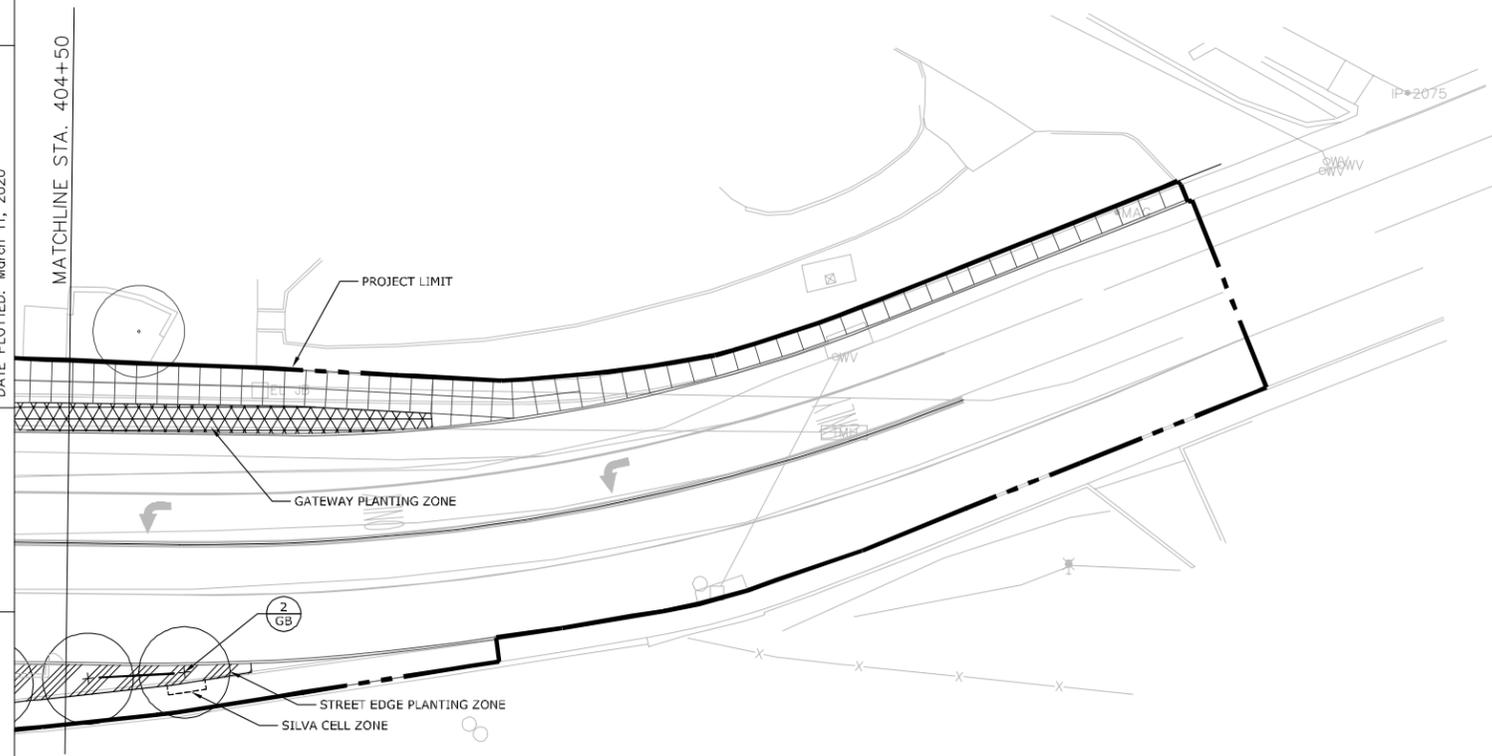


2 MAIN STREET (STA. 404+50 TO END.)
SCALE: 1" = 20'

SCALE: 1"=20'

MAIN STREET (US 60/ KY 420)
BEGINNING TO END.
PLANTING PLAN - AREA 6 & 7

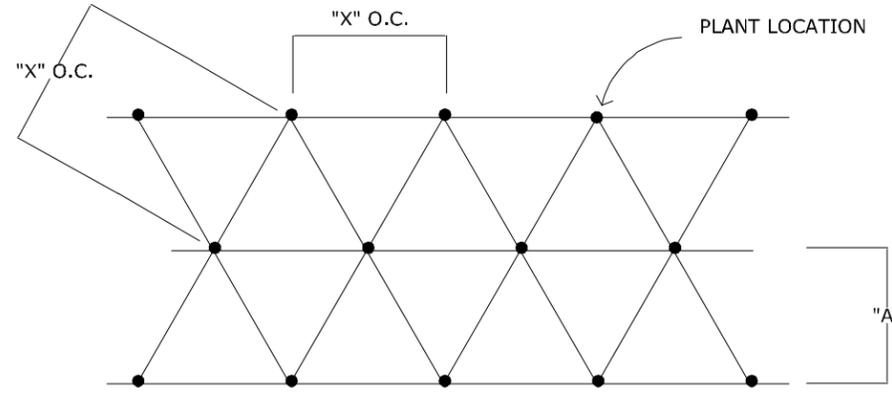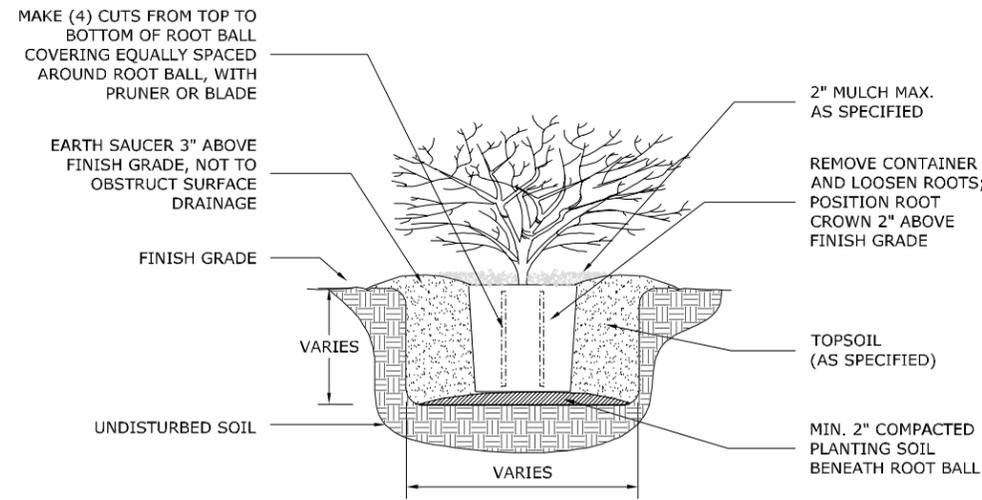


SPACING SCHEDULE	
SPACING "X"	ROW "A"
8" O.C.	7"
12" O.C.	10 1/2"
18" O.C.	15 1/2"
24" O.C.	20 3/4"
30" O.C.	26"
36" O.C.	31"
42" O.C.	3'-0"
5' O.C.	4'-4"

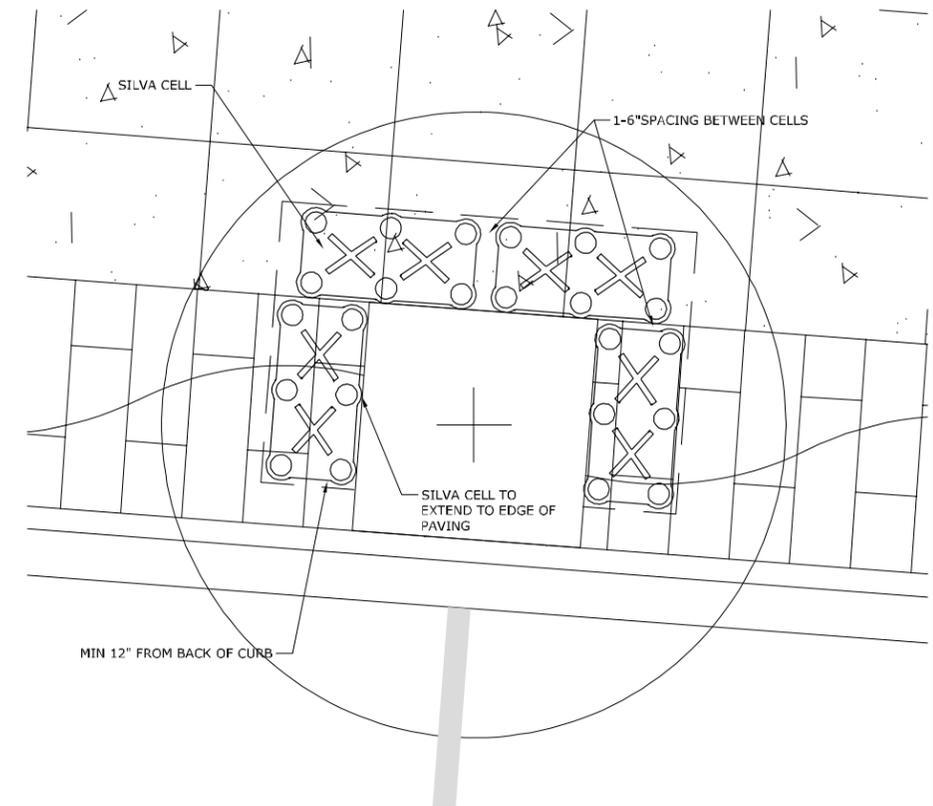

1 TYPICAL CONTAINER SHRUB PLANTING
SCALE: NTS

NOTE: DO NOT EXCAVATE LARGE AREAS FOR BED PREP OR ROTOTILL AROUND EXISTING TREES/ROOTS. COORDINATE ALL PLANTINGS UNDER DRIPLINE OF EXISTING TREES WITH CERTIFIED ARBORIST. ADJUST LAYOUT AS NECESSARY TO AVOID ROOTS. DO NOT DAMAGE TRUNKS OR ROOTS.

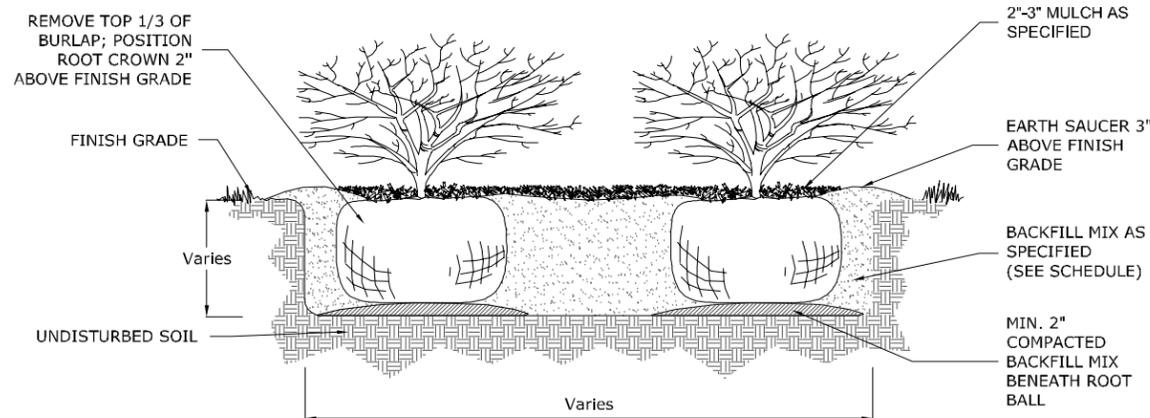


2 TYPICAL B&B SHRUB PLANTING
SCALE: NTS

3 TYPICAL PLANT SPACING
SCALE: NTS

- NOTES:
- 1) BACKFILL WITH PLANTING SOIL.
 - 2) SATURATE THE ENTIRE BACKFILL SOIL WITH WATER. ADD MORE SOIL IF NEEDED TO COMPENSATE FOR SETTLING.
 - 3) MULCH: COVER PLANTING SOIL WITH 2 INCHES OF MULCH. LEAVE GAP NEAR THE TRUNK. REPLACE AS NEEDED.
 - 4) PRUNE ONLY BROKEN OR BADLY DEFORMED BRANCHES TO RETAIN SHAPE OF THE SPECIES. PRUNE OUT SECONDARY AND COMPETING GROWTH. DO NOT SHEAR. DO NOT CUT LEADER. BEGIN A REGULAR PRUNING PROGRAM THE SECOND YEAR AFTER PLANTING.
 - 5) INSTALL ROOT BALL STABILIZATION FOR TREES WITHIN THE PLAZA

4 SILVA CELL ENLARGEMENT (TYP.)
SCALE: NTS

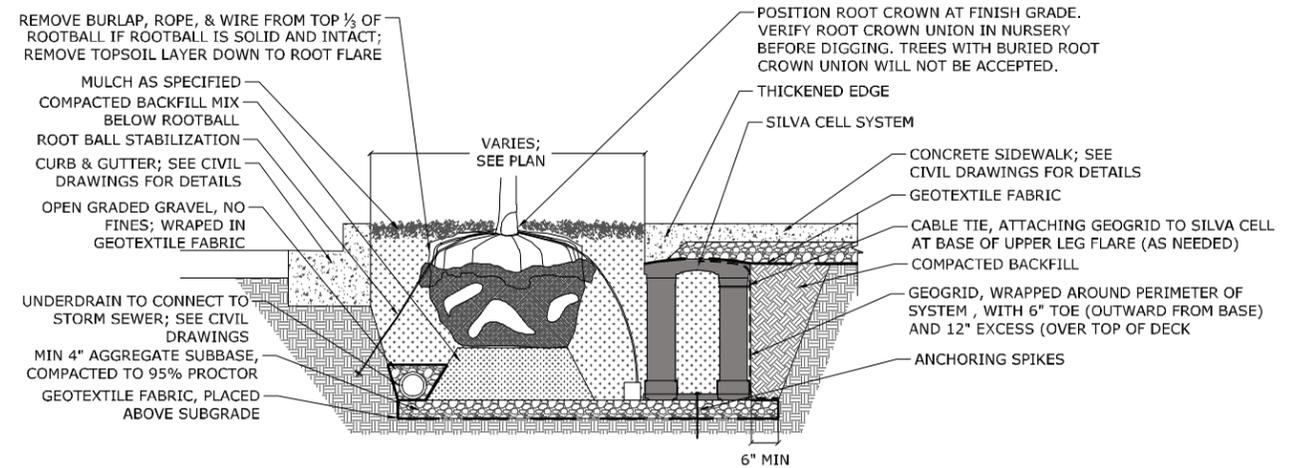

5 TREE PIT WITH SILVA CELL (TYP.)
SCALE: NTS

FILE NAME: X:\21900 PROJECTS\21906 (FRANKFORT 2ND STREET)\AUTOCAD\03_DD\L-307 PLANTING DETAILS.DWG

USER: nfhoh DATE PLOTTED: March 11, 2020

E-SHEET NAME:

Power InRoads v8.11.7.443

TREES



Tilia americana 'McKSentry'
American Sentry Linden



Ginkgo biloba 'Princeton Sentry'
Princeton Sentry Ginkgo



Amelanchier laevis 'Cumulus'
Cumulus Allegheny Serviceberry



Quercus bicolor 'JFS-KW12'
American Dream Swamp White Oak

GREEN INFRASTRUCTURE SHRUBS & PERENNIALS



Symphoricarpos orbiculatus 'Proud Berry'
Proud Berry Coral Berry



Aronia melanocarpa 'Low Scape Mound'
Low Scape Mound Black Chokeberry



Coreopsis verticillata 'Zagreb'
Zagreb Threadleaf Tickseed



Panicum virgatum 'Prairie Winds Cheyenne Sky'
Prairie Winds® 'Cheyenne Sky' Switch Grass

GATEWAY LANDSCAPE SHRUBS & PERENNIALS



Rudbeckia fulgida
Orange Coneflower



Aronia melanocarpa 'Low Scape Mound'
Low Scape Mound Black Chokeberry



Fragrostis spectabilis
Purple Love Grass



Ceanothus americanus
New Jersey Tea

STREET EDGE LANDSCAPE SHRUBS & PERENNIALS



Rudbeckia fulgida
Orange Coneflower



Aronia melanocarpa 'Low Scape Mound'
Low Scape Mound Black Chokeberry



Fragrostis spectabilis
Purple Love Grass



Panicum virgatum 'Prairie Winds Cheyenne Sky'
Prairie Winds® 'Cheyenne Sky' Switch Grass



Coreopsis verticillata 'Zagreb'
Zagreb Threadleaf Tickseed



Schizachyrium scoparium 'The Blues'
The Blues Little Bluestem

COUNTY OF	ITEM NO.	SHEET NO.
FRANKLIN	5-565	L-308

FILE NAME: X:\21900 PROJECTS\21906 (FRANKFORT 2ND STREET)\AUTOCAD\03_DD\L-308 PLANT SWITCH.DWG

USER: nhh
DATE PLOTTED: March 11, 2020

E-SHEET NAME:

Power InRoads v8.11.7.443